




DEPARTMENT OF HEALTH, EDUCATION, AND WELFARE
PUBLIC HEALTH SERVICE

These Plans and Specifications are submitted in connection with an Application for a Federal grant for the construction of treatment works under the provisions of the Federal Water Pollution Control Act (see below) and the regulations promulgated thereunder have been reviewed.


EXAMINED and reported upon by the Section on Environmental Sanitation	O. J. MUEGGE State Sanitary Engineer
APPROVED by the State Board of Health, as required by Wisconsin Statutes, subject to conditions set forth in the letter of approval	CARL N. NEUPERT, M. D. State Health Officer
JUL 6 1956	Verification <u>D. Scammon</u>

Note:
Curb & Gutter to be
8' H } 18' W } Min. Highway Dept. Plot 7101B
SLOPE-1% MIN TO DRAIN PROPERLY
CONTRACTOR TO INSTALL 8' PRE-CAST
CONNECTION, ON PILING, FROM PRESENT
UTFALL SEWER TO NEW BY-PASS STRUCTURE
AND SEAL TO PREVENT LEAKAGE.

REVISIONS		
DATE	DESCRIPTION	BY
6-19 8-3-52	CHANGED FROM 10' TO 12' REMOVED WHITE GAS BURNER M.E. 811.	J.P. E.M.
SEWAGE TREATMENT PLANT GENERAL LAYOUT		
SUPERIOR WIS.		
HITCHCOCK & ESTABROOK, INC. CONSULTING ENGINEERS 300 LINCOLN BLDG. MINNEAPOLIS 1, MINN.		
DR. <input type="checkbox"/> JL <input checked="" type="checkbox"/> CHKD. <input type="checkbox"/> APPD. <input checked="" type="checkbox"/>		JOB NO. 400 SHEET NO. 13 OF 71
DATE: 8/19/52 SCALE: 1"		

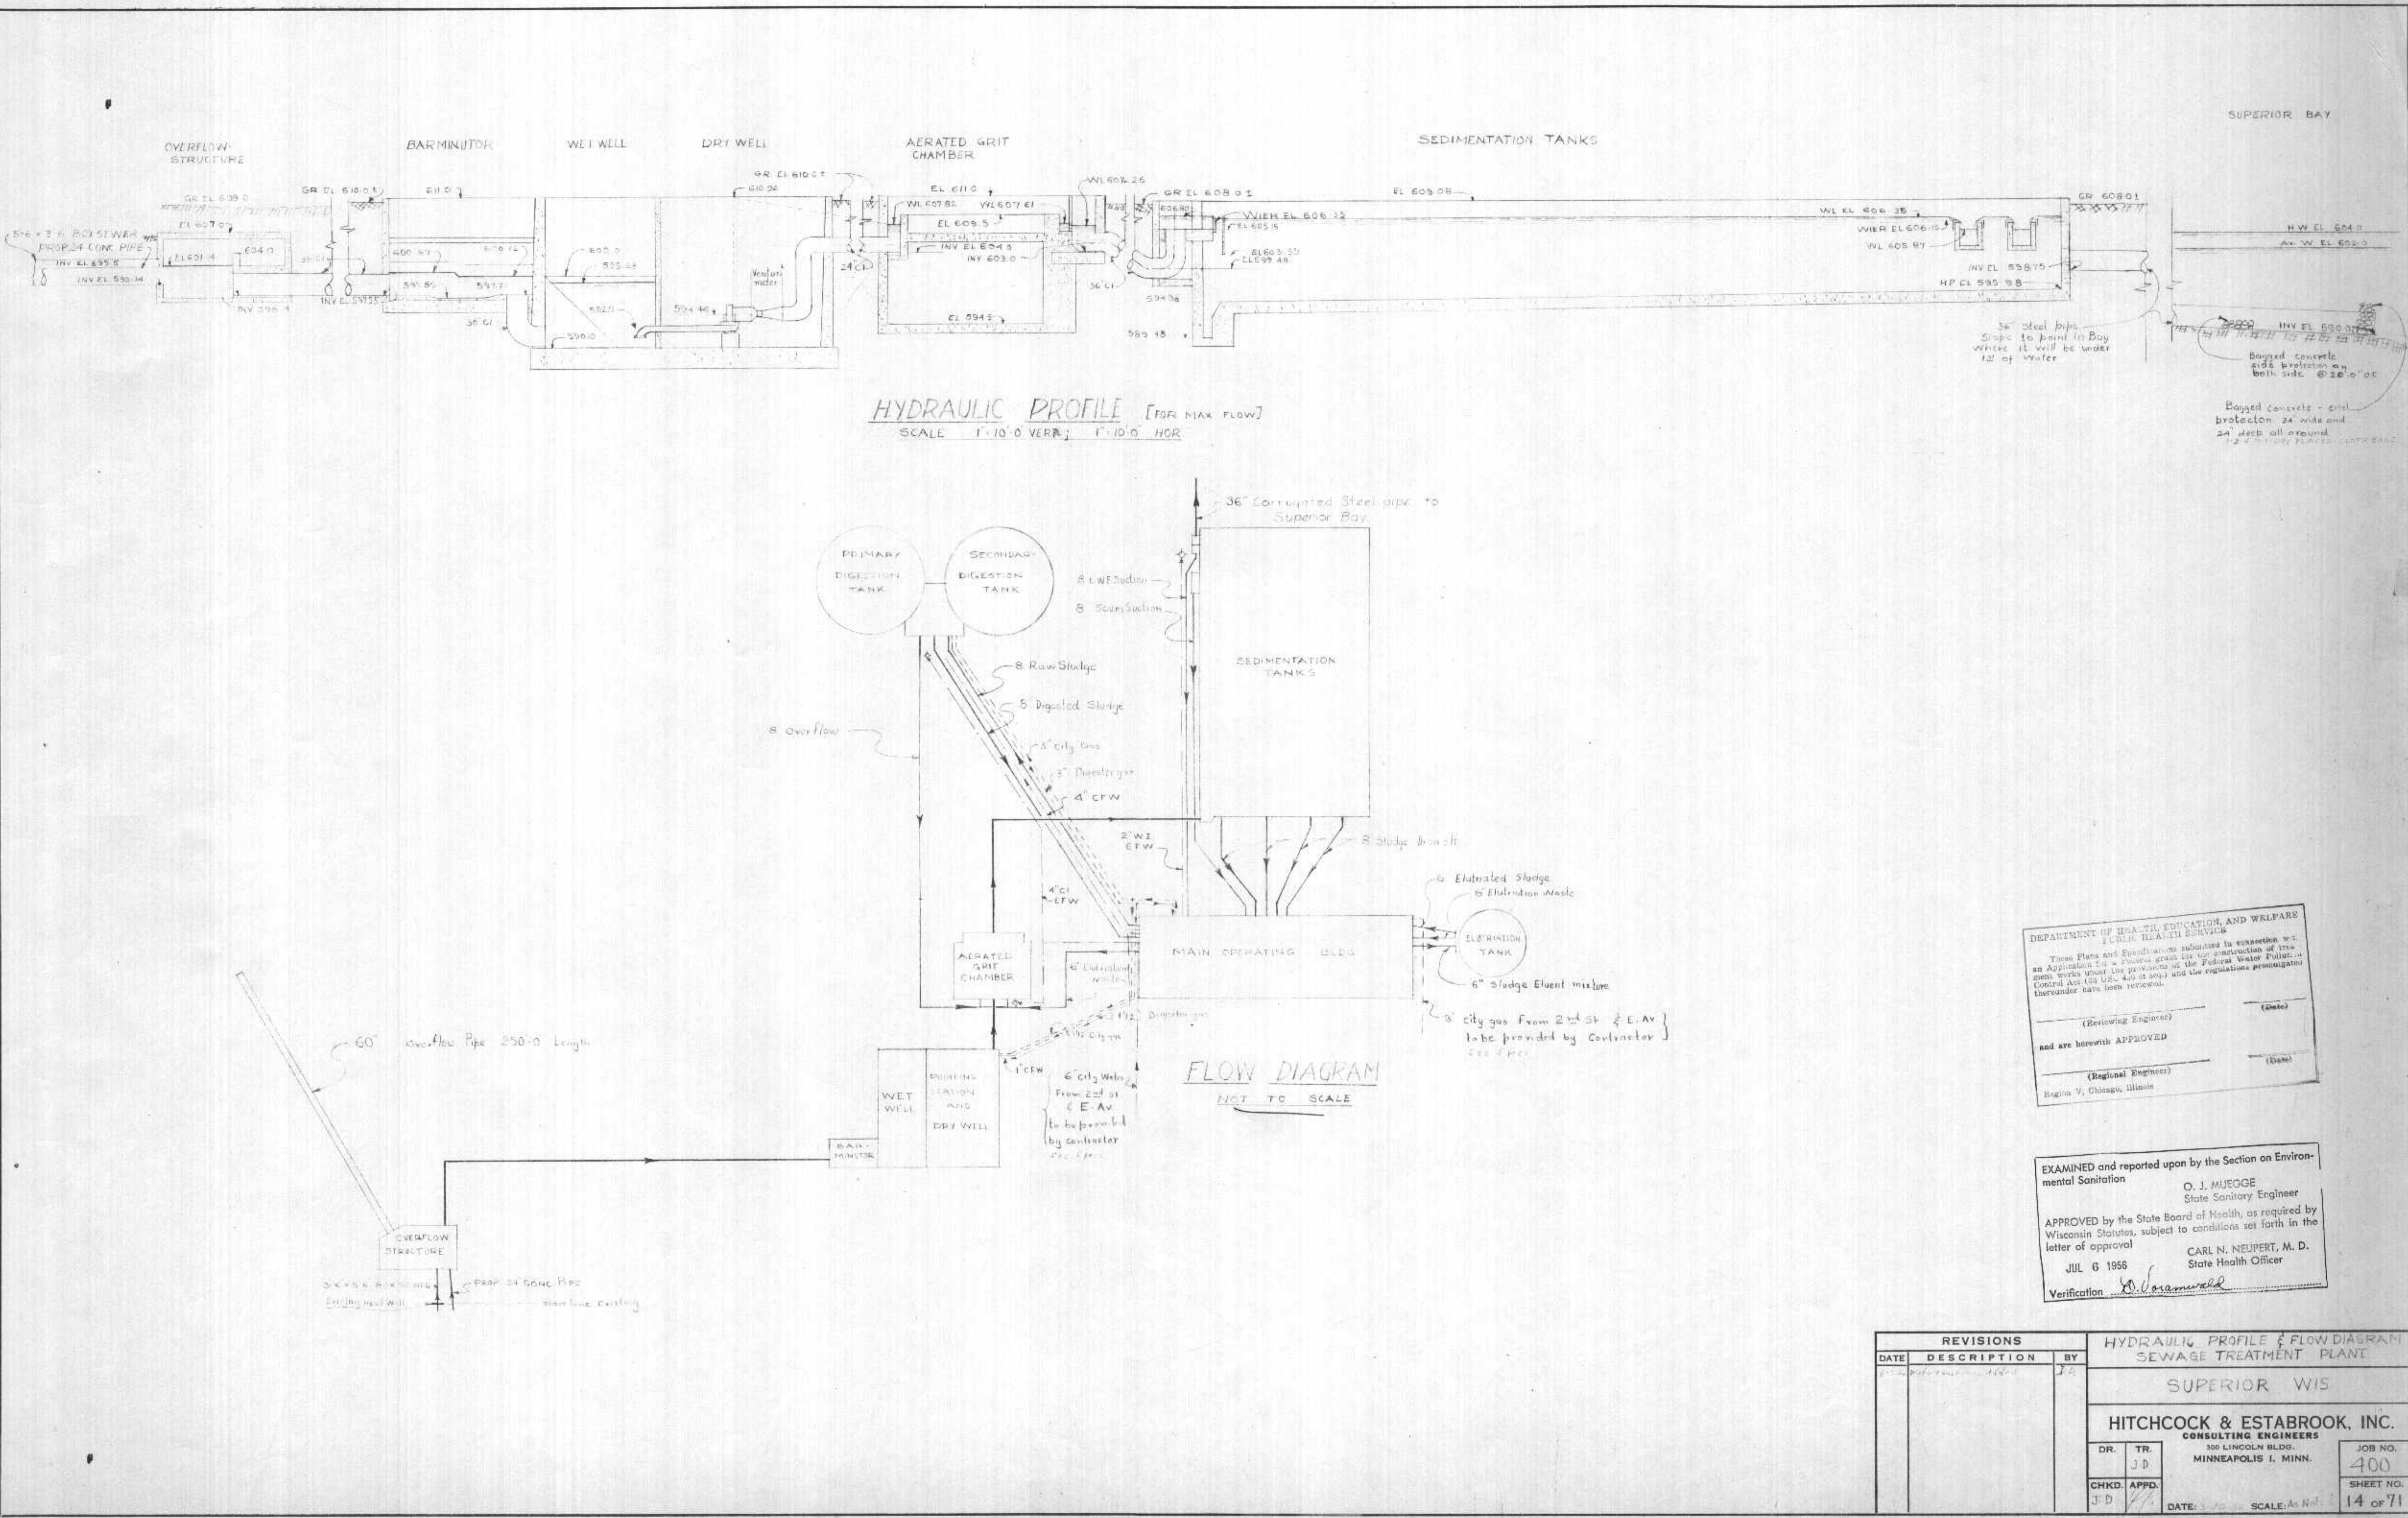

57557
4
58952

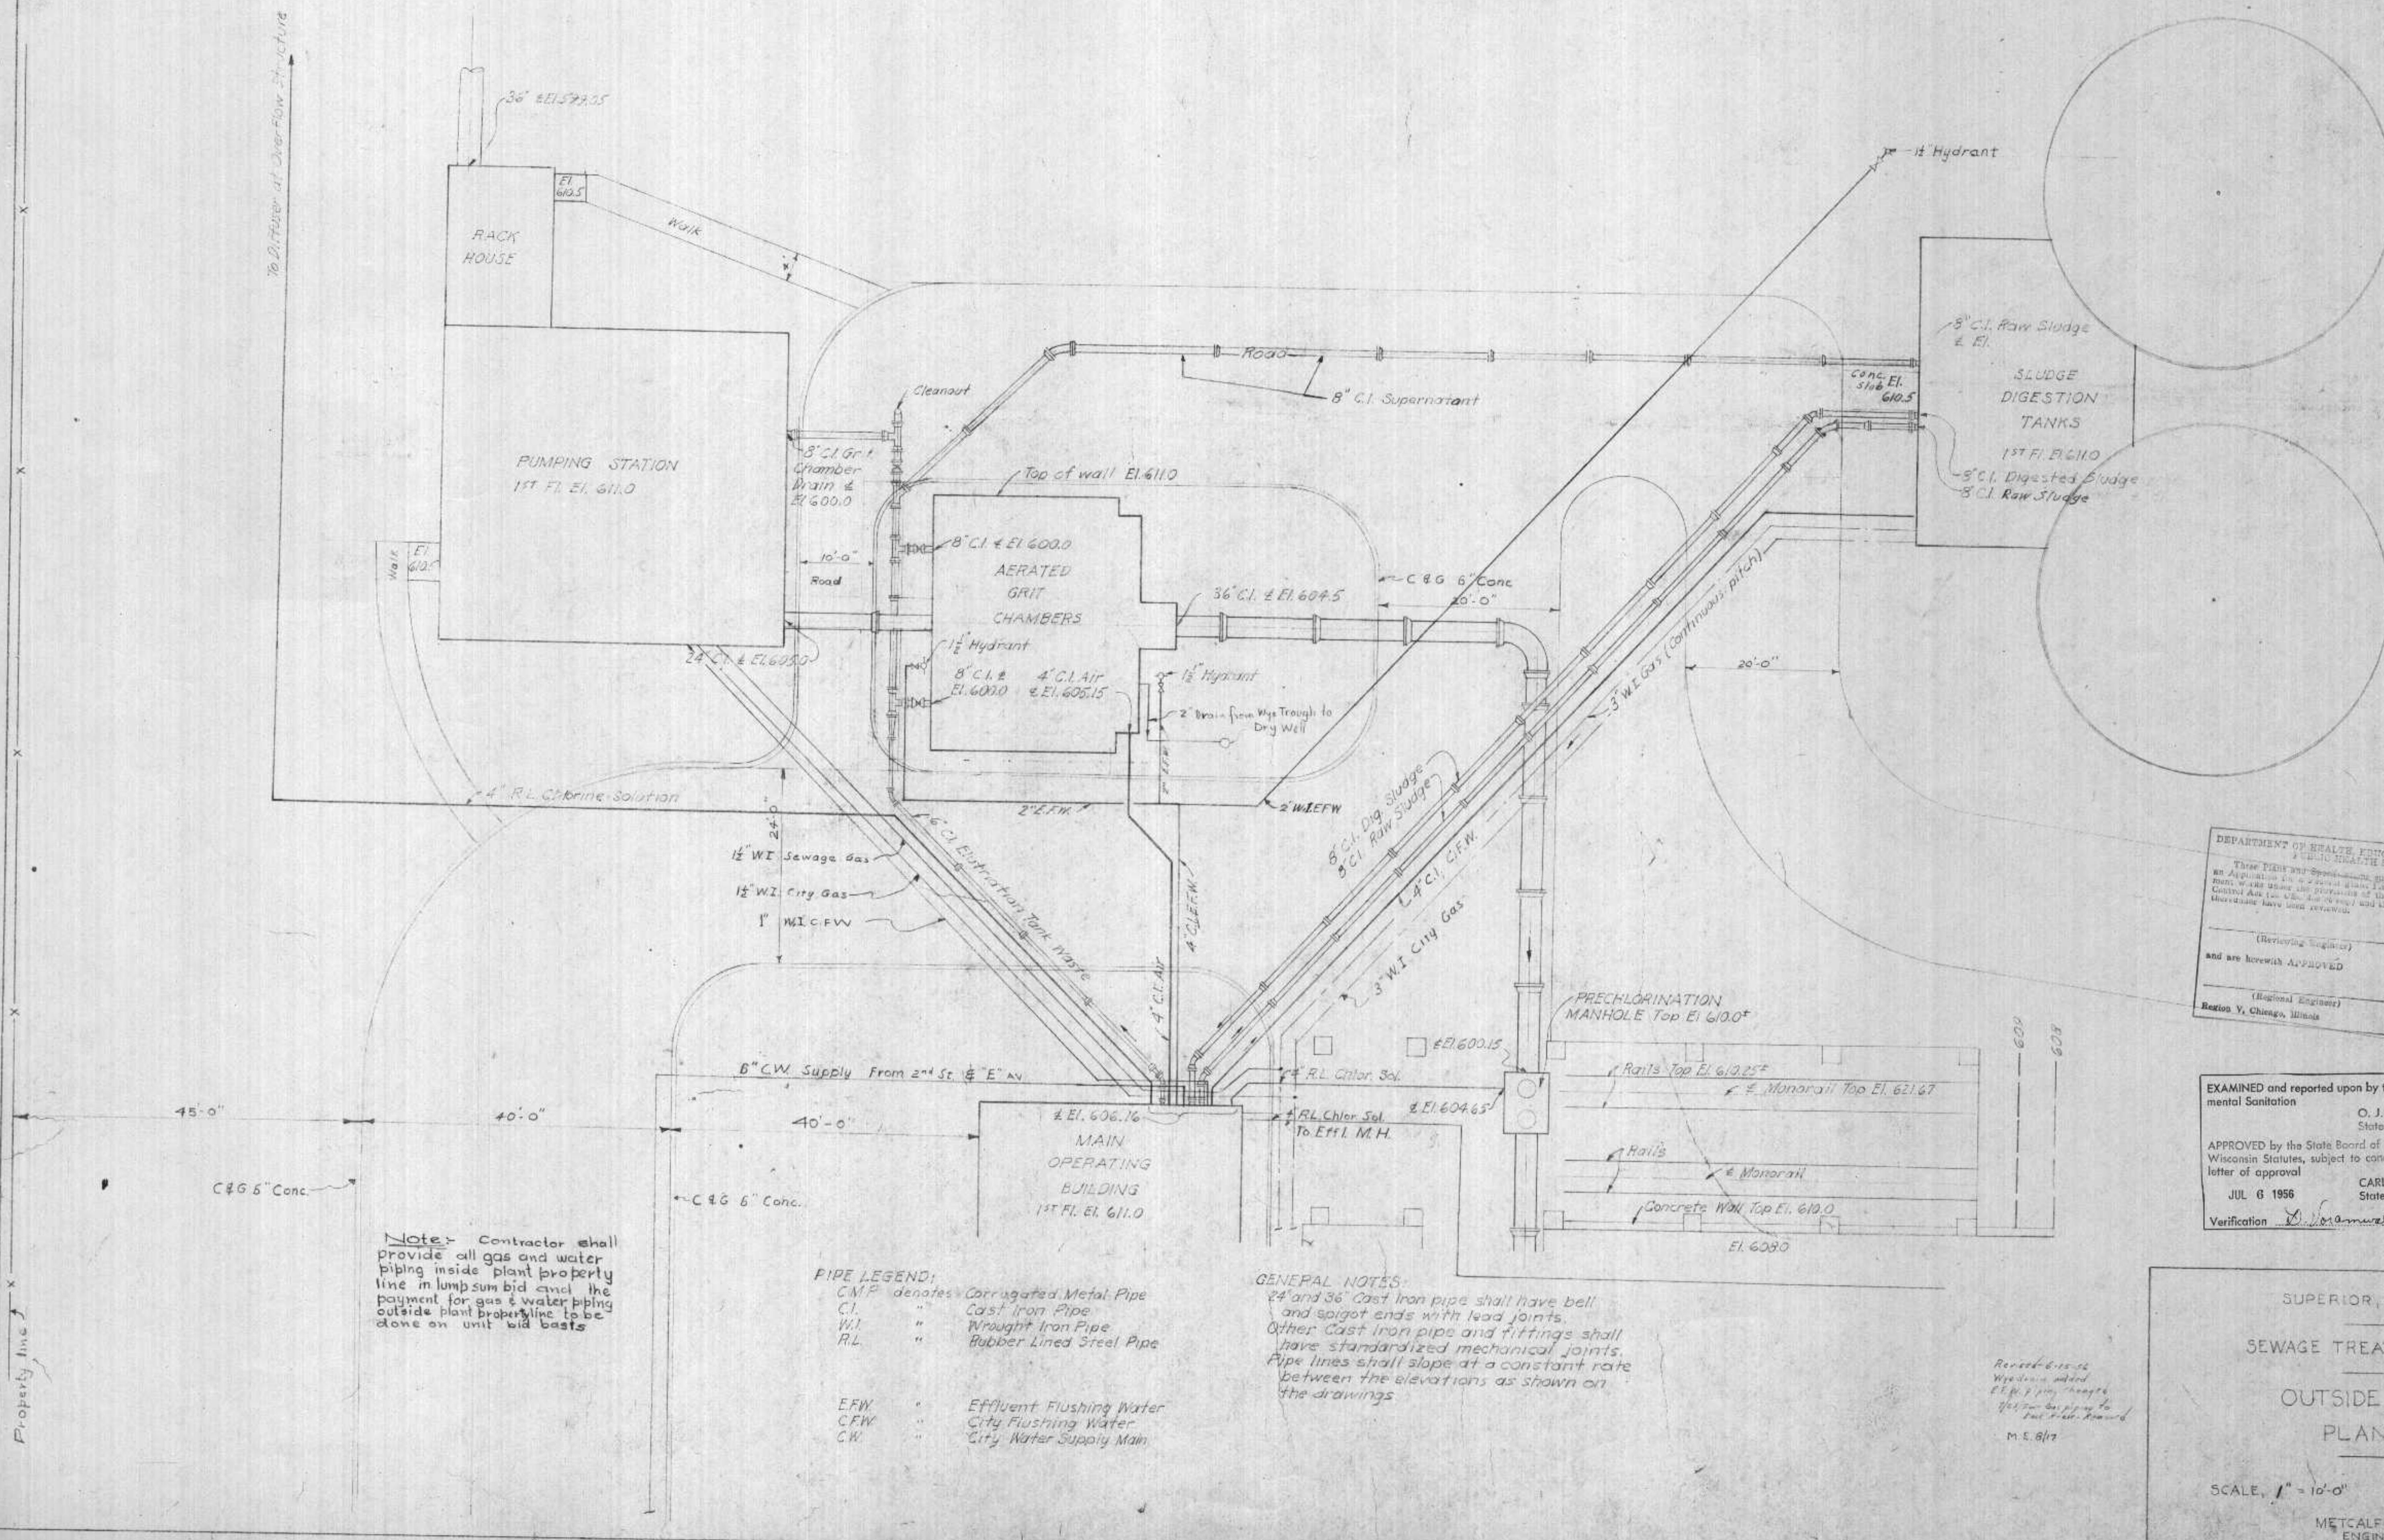


DEPARTMENT OF HEALTH EDUCATION, AND WELFARE
U. S. PUBLIC HEALTH SERVICE

Three Plans and Specifications submitted in connection with
an Application for a Federal Health Unit or Construction of the
main, w/ the minor site provisions of the Federal Water Power
Control Act (the C.W.P.A.) and the requirements promulgated
thereunder have been reviewed.

EXAMINED and reported upon by the Section on Environmental Sanitation
O. J. MUEGGE
State Sanitary Engineer
APPROVED by the State Board of Health, as required by Wisconsin Statutes, subject to conditions set forth in the letter of approval
CARL N. NEUPERT, M. D.
State Health Officer
JUL 6 1956
Verification O. J. Muegge

SUPERIOR, WISCONSIN
SEWAGE TREATMENT PLANT
OUTSIDE PIPING
PLAN - I

SCALE, 1" = 10'-0" FEB. 1956
METCALF & EDDY
ENGINEERS'
BOSTON, MASS.
400 SHEET NO 61 OF 71

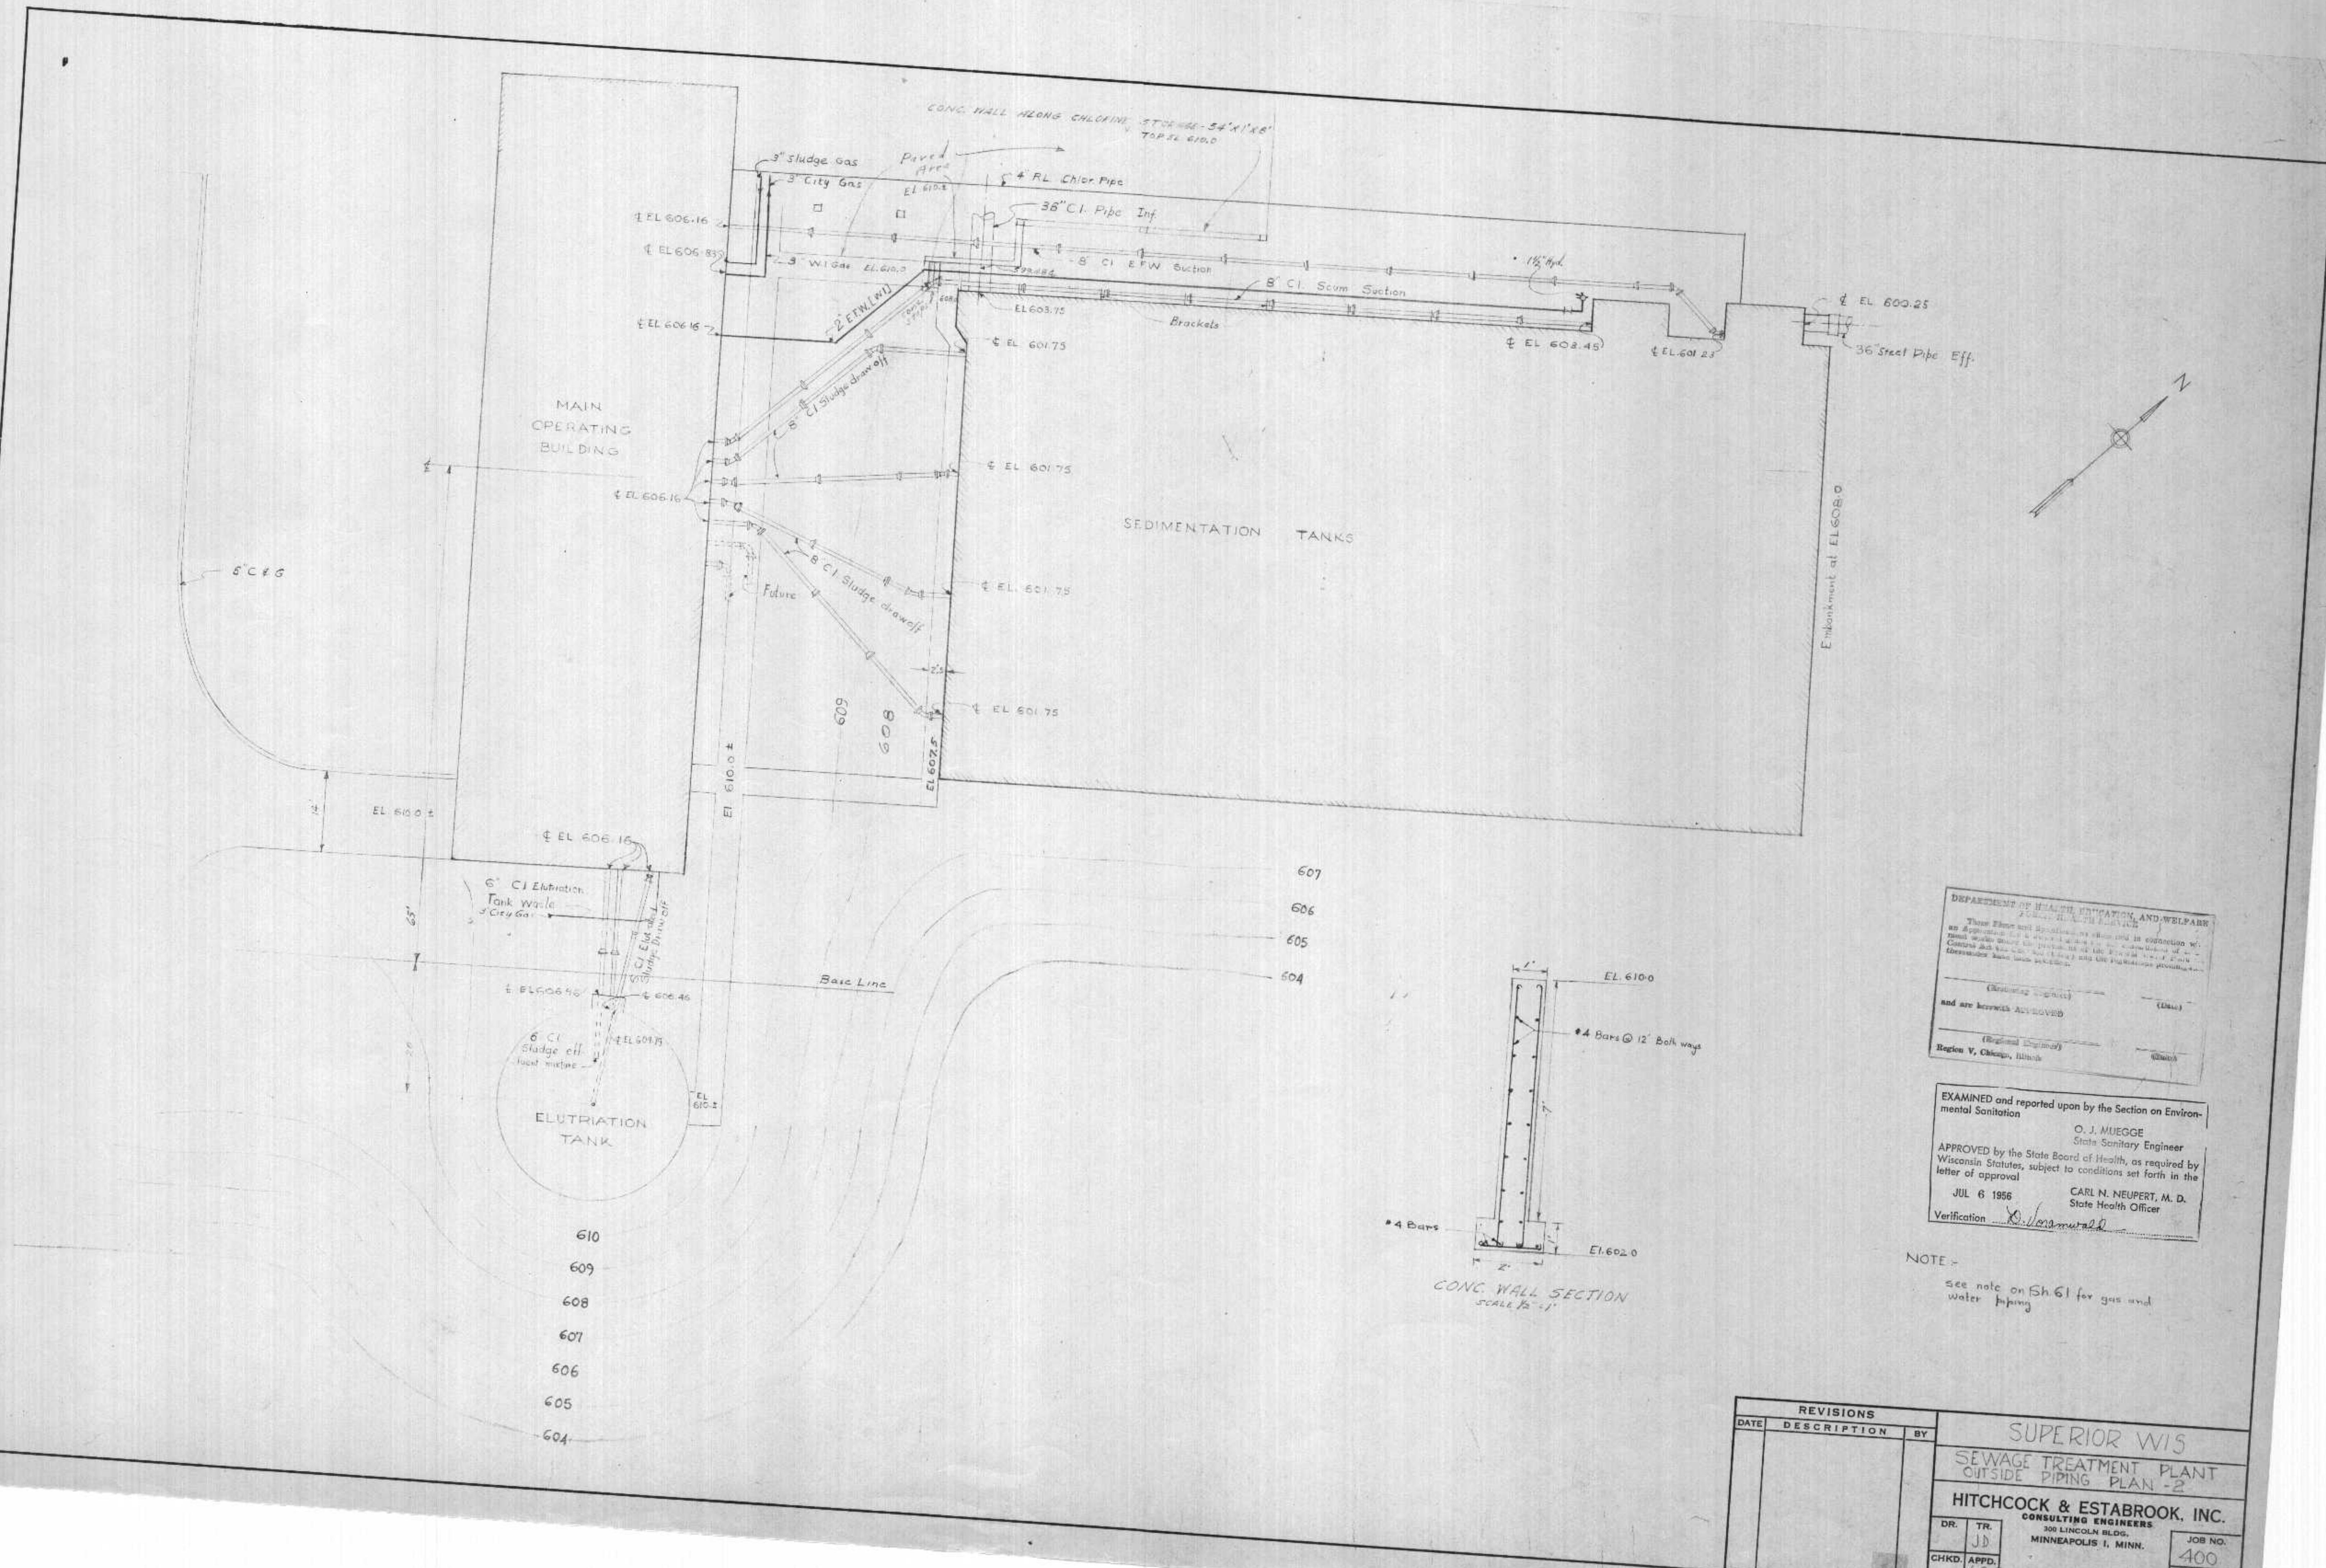

DESIGN INFORMATION

AVERAGE DRY WEATHER FLOW
MAX. HYDRAULIC CAPACITY - SECONDARY
MAX. HYDRAULIC CAPACITY - RETENTION TANK
B.O.D. LOADING - AVERAGE
B.O.D. CONCENTRATION - AVERAGE
S.S. LOADING - AVERAGE
S.S. CONCENTRATION - AVERAGE
PHOSPHORUS AS "P"
POPULATION EQUIVALENT
RETENTION TANK
GRIT BASINS
PRIMARY TANKS
AERATION TANKS
FINAL TANKS
CHLORINE CONTACT TANKS
ANAEROBIC DIGESTERS
AIR

5.0 MGD
15.0 MGD
50.0 MGD
7,500 LBS / DAY
180 MG/L
8,500 LBS / DAY
200 MG/L
10 MG/L
44,000
30 MIN. DETENTION (MINIMUM)
100 MESH RETENTION
665 GAL / SQ. FT. / DAY
50 LBS / 1,000 CU. FT.
650 GAL / SQ. FT. / DAY
15 MIN. DETENTION (MINIMUM)
30 DAY DETENTION
2,300 CU. FT. / LB. B.O.D.

- 1 TITLE SHEET
- 2 LOCATION PLAN & INDEX
- 3 FLOW DIAGRAM
- 4 HYDRAULIC PROFILES
- 5 EXISTING SITE LAYOUT
- 6 PROPOSED SITE LAYOUT
- 7 FIELD PIPING & GRADING
- 8 OVERFLOW BYPASS MODIFICATIONS
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REVIEWED AND APPROVED BY THE
DIV. OF ENVIRONMENTAL PROTECTION,
DEPT. NATURAL RESOURCES,
IN ACCORDANCE WITH SEC. 144.04,
WIS. STATS., SUBJECT TO THE CON-
DITIONS SET FORTH IN THE LETTER
OF APPROVAL.

THOMAS G. FRANCIS
ADMINISTRATOR

APPROVAL NO.
72 355

DATE: FEB 4 1974

DNR JAN 3 1974


LOCATION PLAN


SURVEY	REVISIONS
DRAWN	
DESIGNED	
APPROVED	

BONESTROO, ROSENE, ANDERLIE & ASSOC., INC.
ST. PAUL, MINNESOTA


SUPERIOR, WISCONSIN
DATE: FEBRUARY 2, 1974
COMM. 6685A

LOCATION PLAN
AND . . .

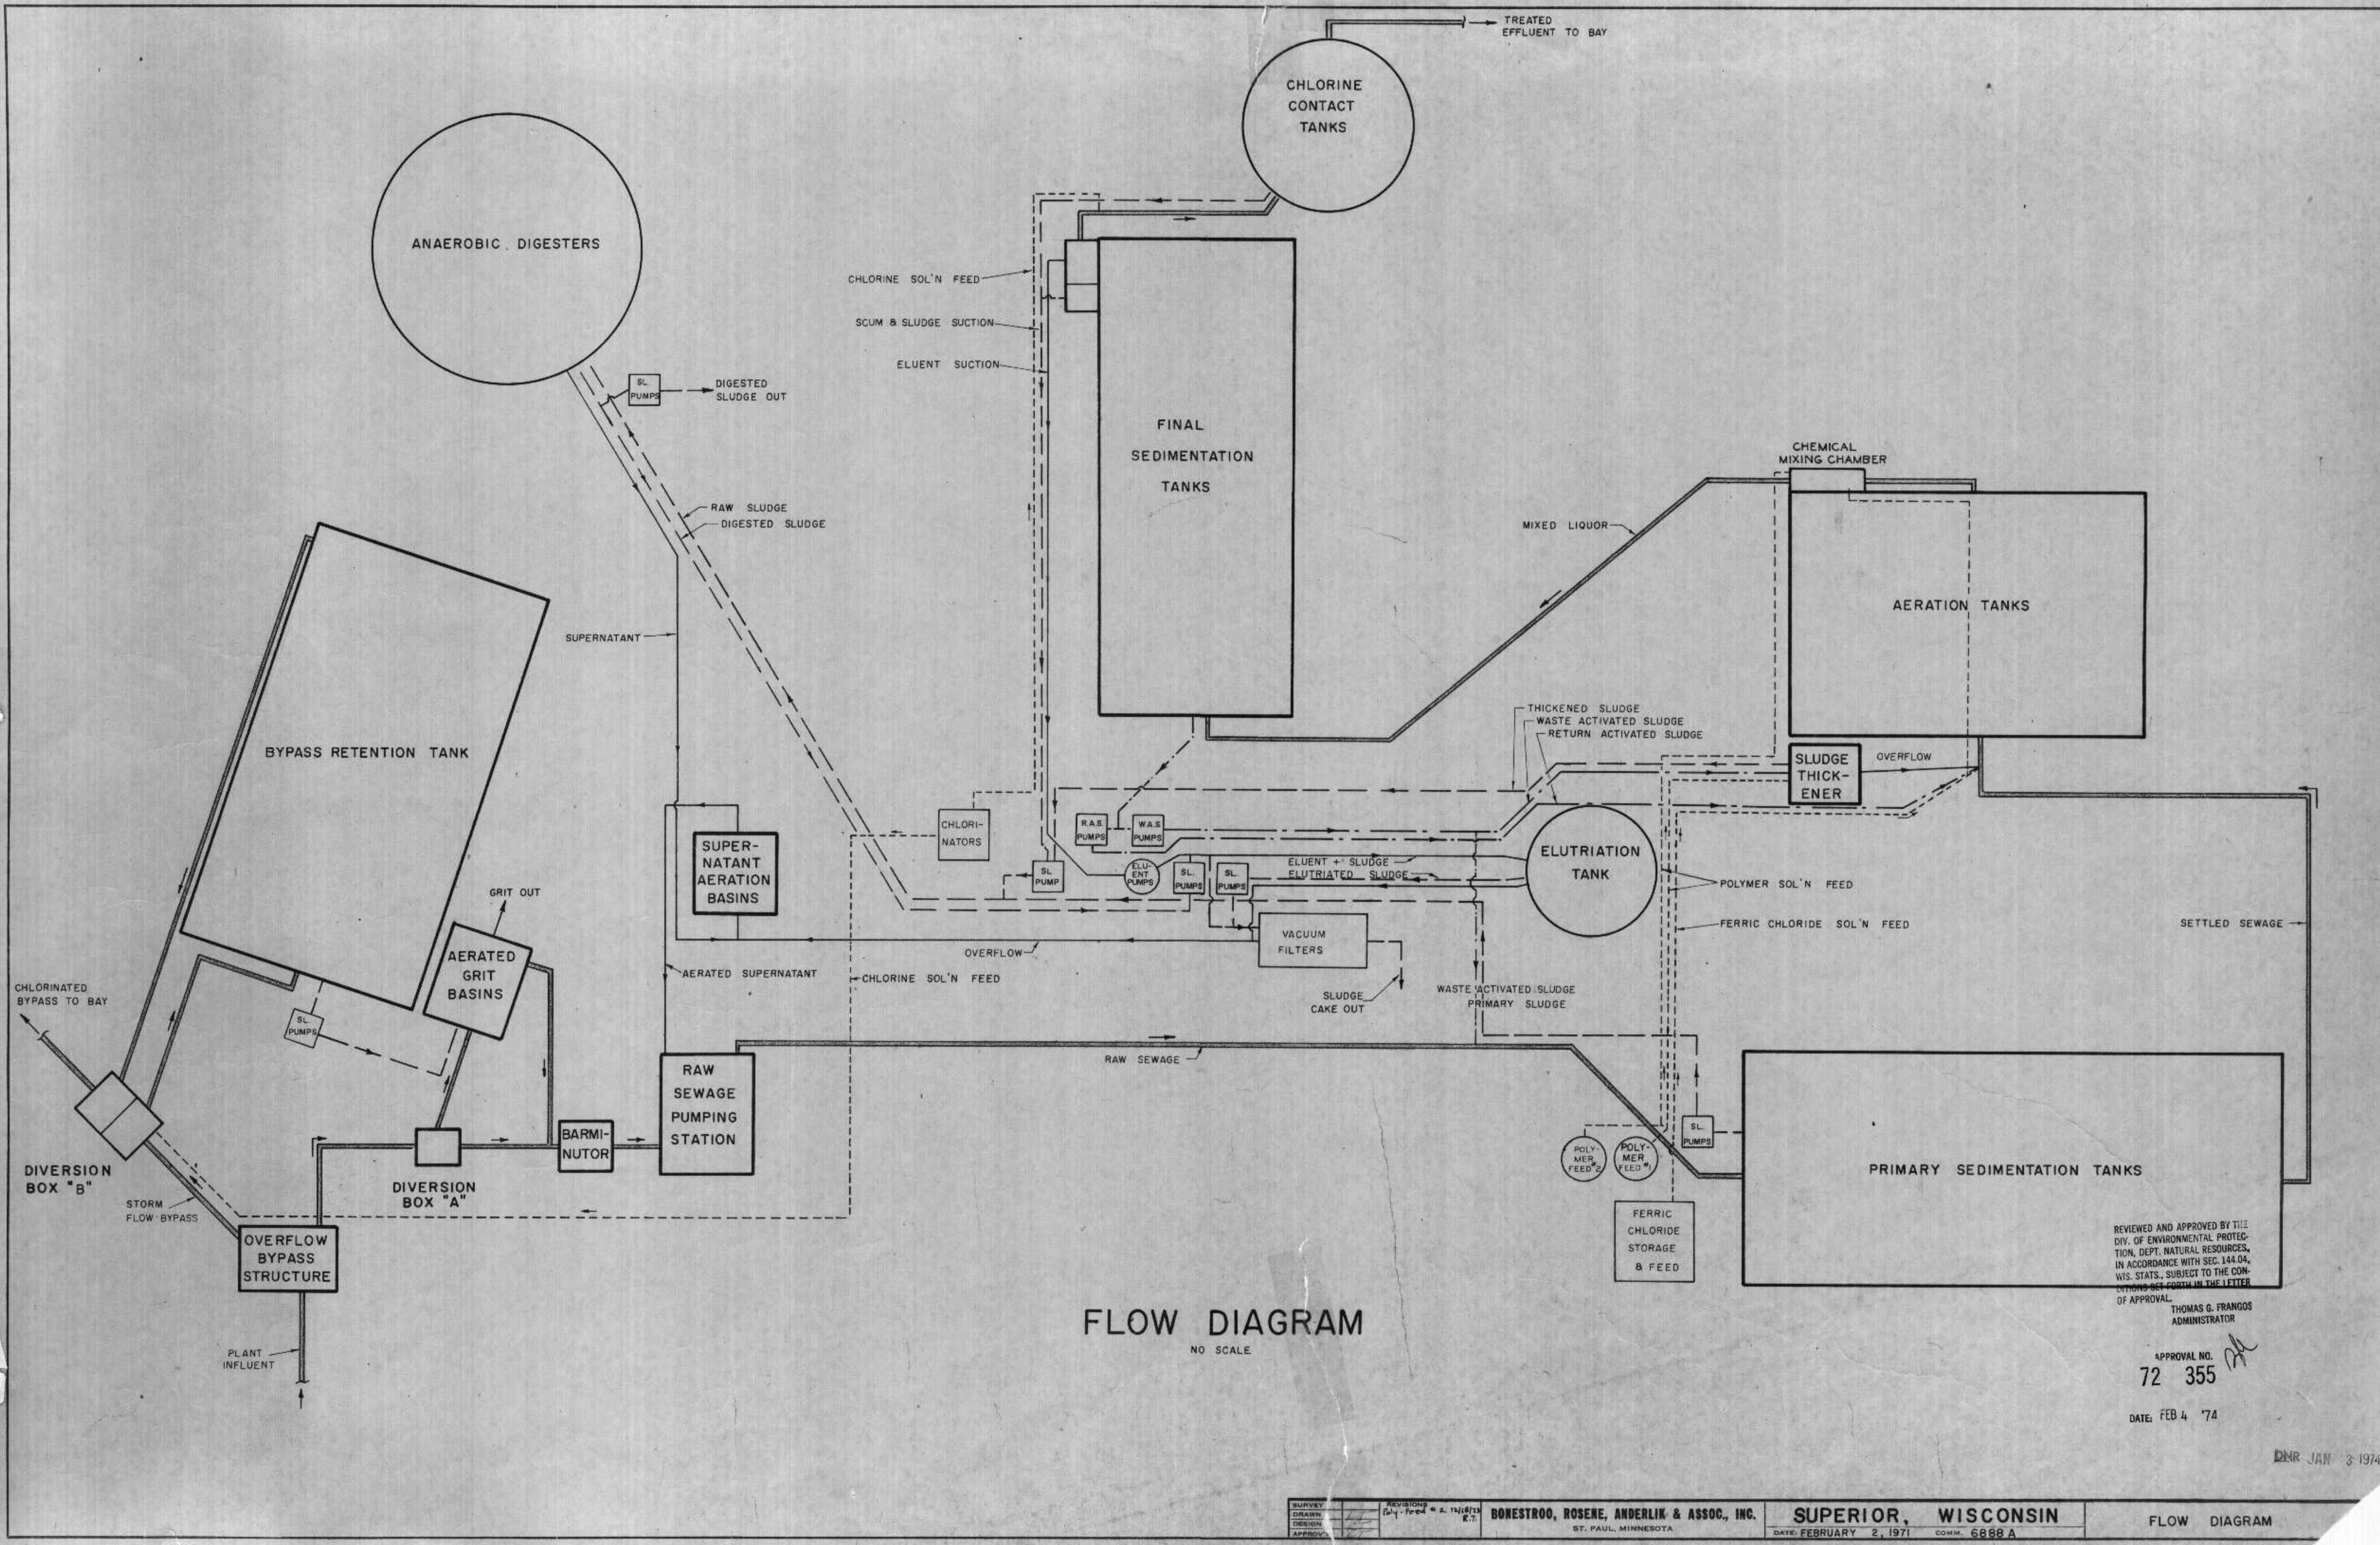

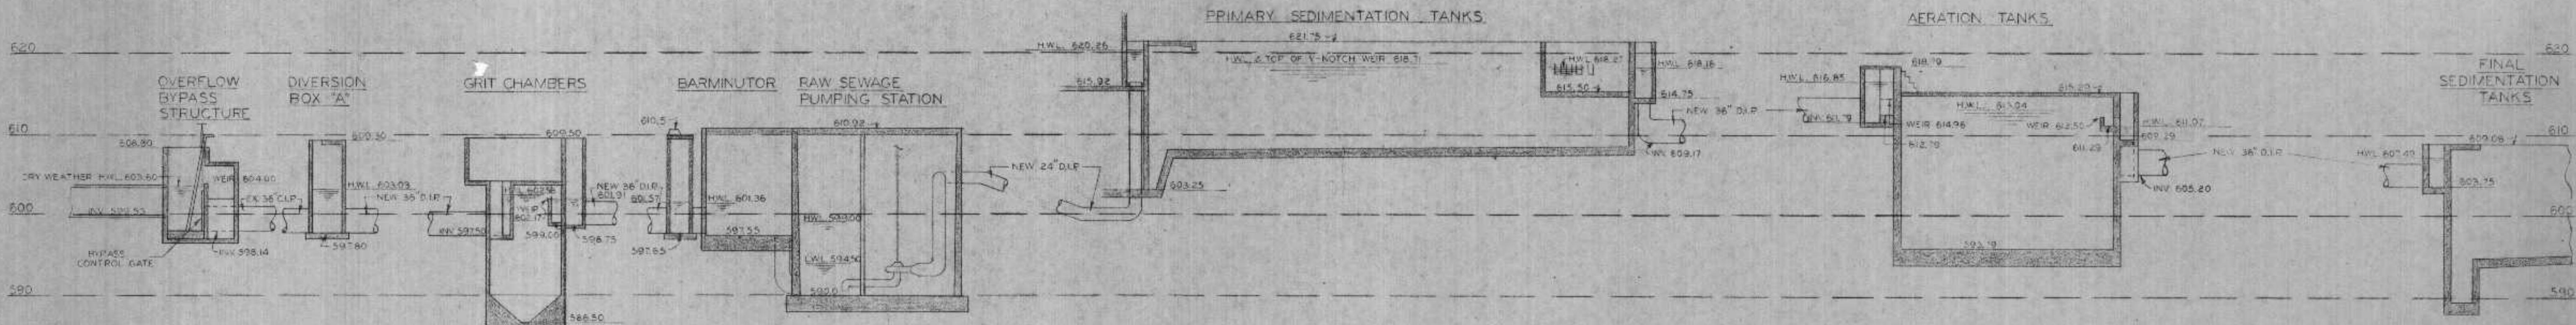


CONTINUED BELOW AT LEFT

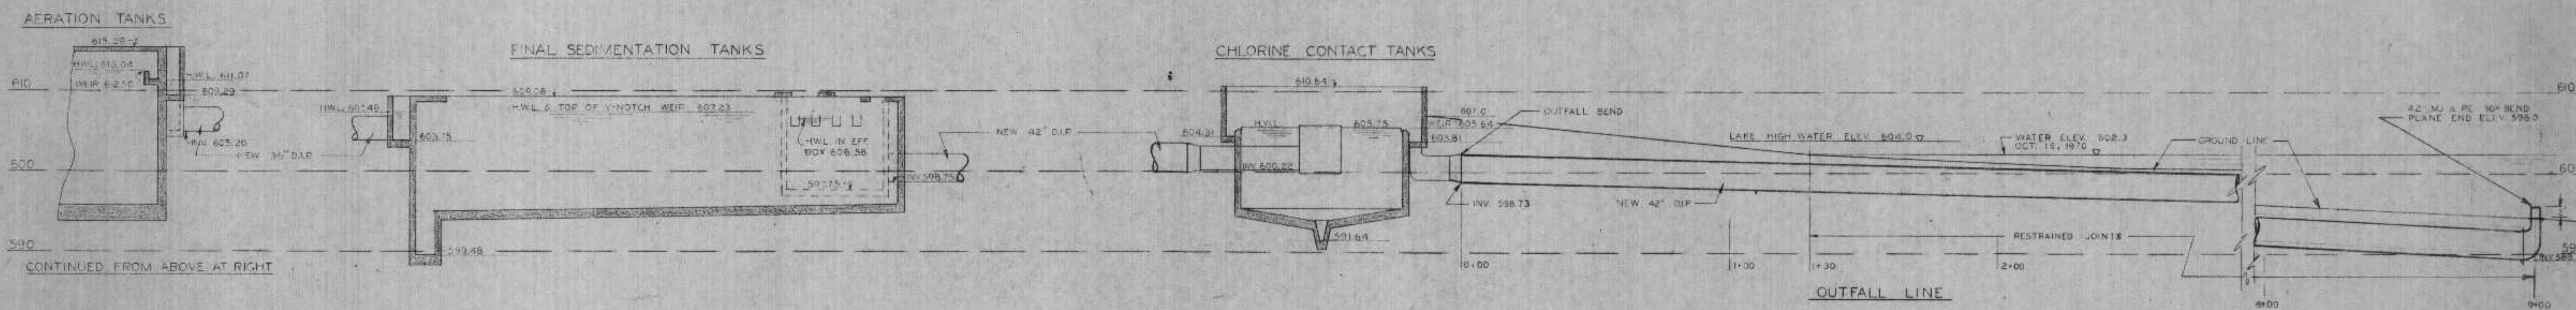

MAIN TREATMENT PLANT SEQUENCE

AT MAXIMUM FLOW

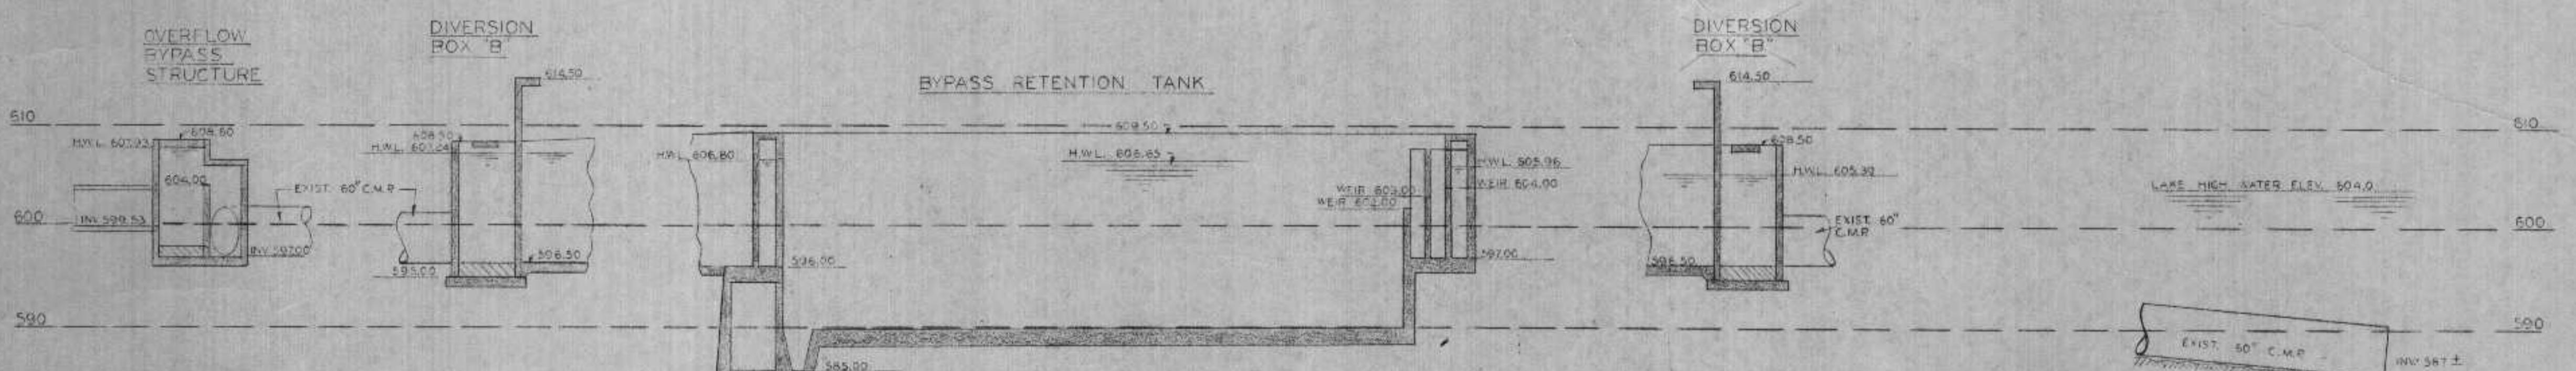

WET WEATHER BYPASS SEQUENCE
AT MAXIMUM FLOW & LAKE HIGH WATER ELEVATION —
H.W.L.'S APPROX 20' OVER AT NORMAL LAKE WATER ELEVATION

REVIEWED AND APPROVED BY THE
DIV. OF ENVIRONMENTAL PROTEC-
TION, DEPT. NATURAL RESOURCES,
IN ACCORDANCE WITH SEC. 144.04.
VIS. STATS., SUBJECT TO THE CON-
DITIONS SET FORTH IN THE LETTER
OF APPROVAL.

APPROVAL NO.
2 355

DATE: FEB 4 '74

HYDRAULIC PROFILES

HORIZ $I = 20'$
VERT $I = 10'$


SURVEY	REVISIONS
DRAWN	44
DESIGN	44
APPROVED	44

BONESTROO, ROSENE, ANDERLIK & ASSOC., INC.
ST. PAUL, MINNESOTA

SUPERIOR, WISCONSIN
FEBRUARY 2, 1971 COMM 6888A

HYDRAULIC PROFILES

SOIL BORING LOG

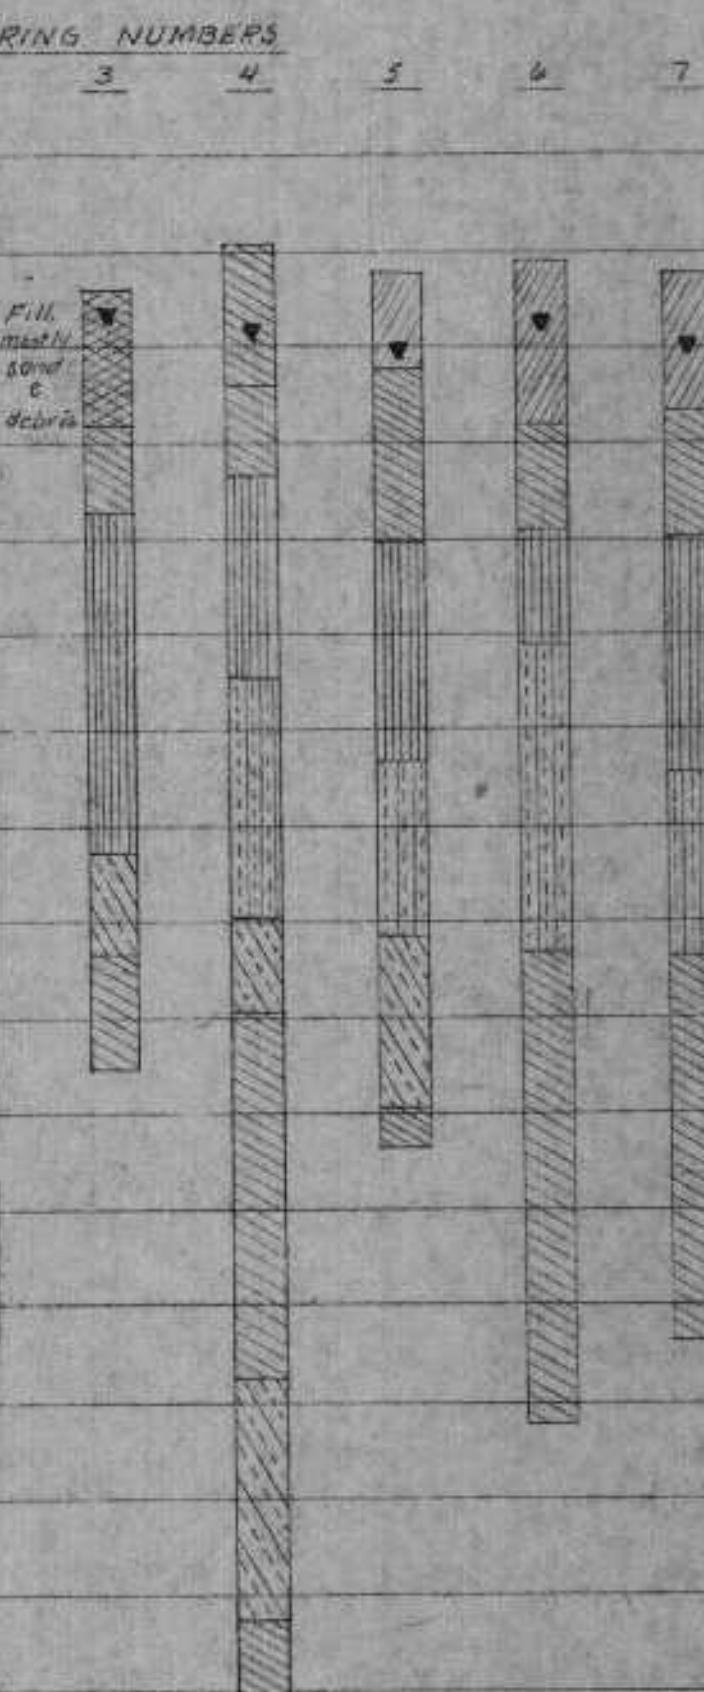

Boring Scale 1"=20' Vertical
Demarcates Water Table - Jan. 1970

SOIL NOTES:
 1. Each symbol for soil is labeled only once in log.
 Recurrence of symbol is for same type of soil.
 2. Soil Borings shown here were made by Lekhav Testing Laboratory, Inc., Duluth, Minnesota, during Jan. 1970.
 3. Soil borings are shown for information only and no warranty is given on varying conditions. The contractor shall be responsible for determining and investigating soil conditions prior to bidding.

WATER LINE
Nov. 11, 1965
Elev. 607.8


RAILROAD
Nov. 11, 1965
Elev. 607.8

REVIEWED AND APPROVED BY THE
DIV. OF ENVIRONMENTAL PROTECTION,
DEPT. NATURAL RESOURCES,
IN ACCORDANCE WITH SEC. 144.04,
WIS. STATS. SUBJECT TO THE CONDITIONS SET FORTH IN THE LETTER OF APPROVAL.

THOMAS G. FRANOS
ADMINISTRATOR


APPROVAL NO.
72 355

DATE FEB 4 '74

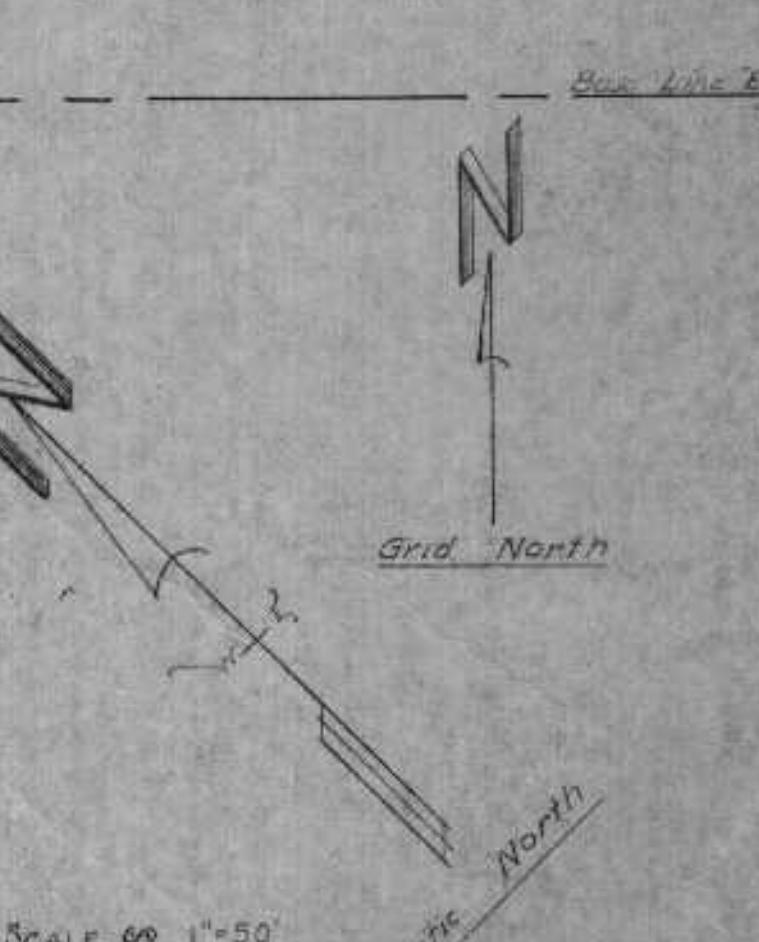


SCALE 60 1"=50'

DNR JAN 3 1974

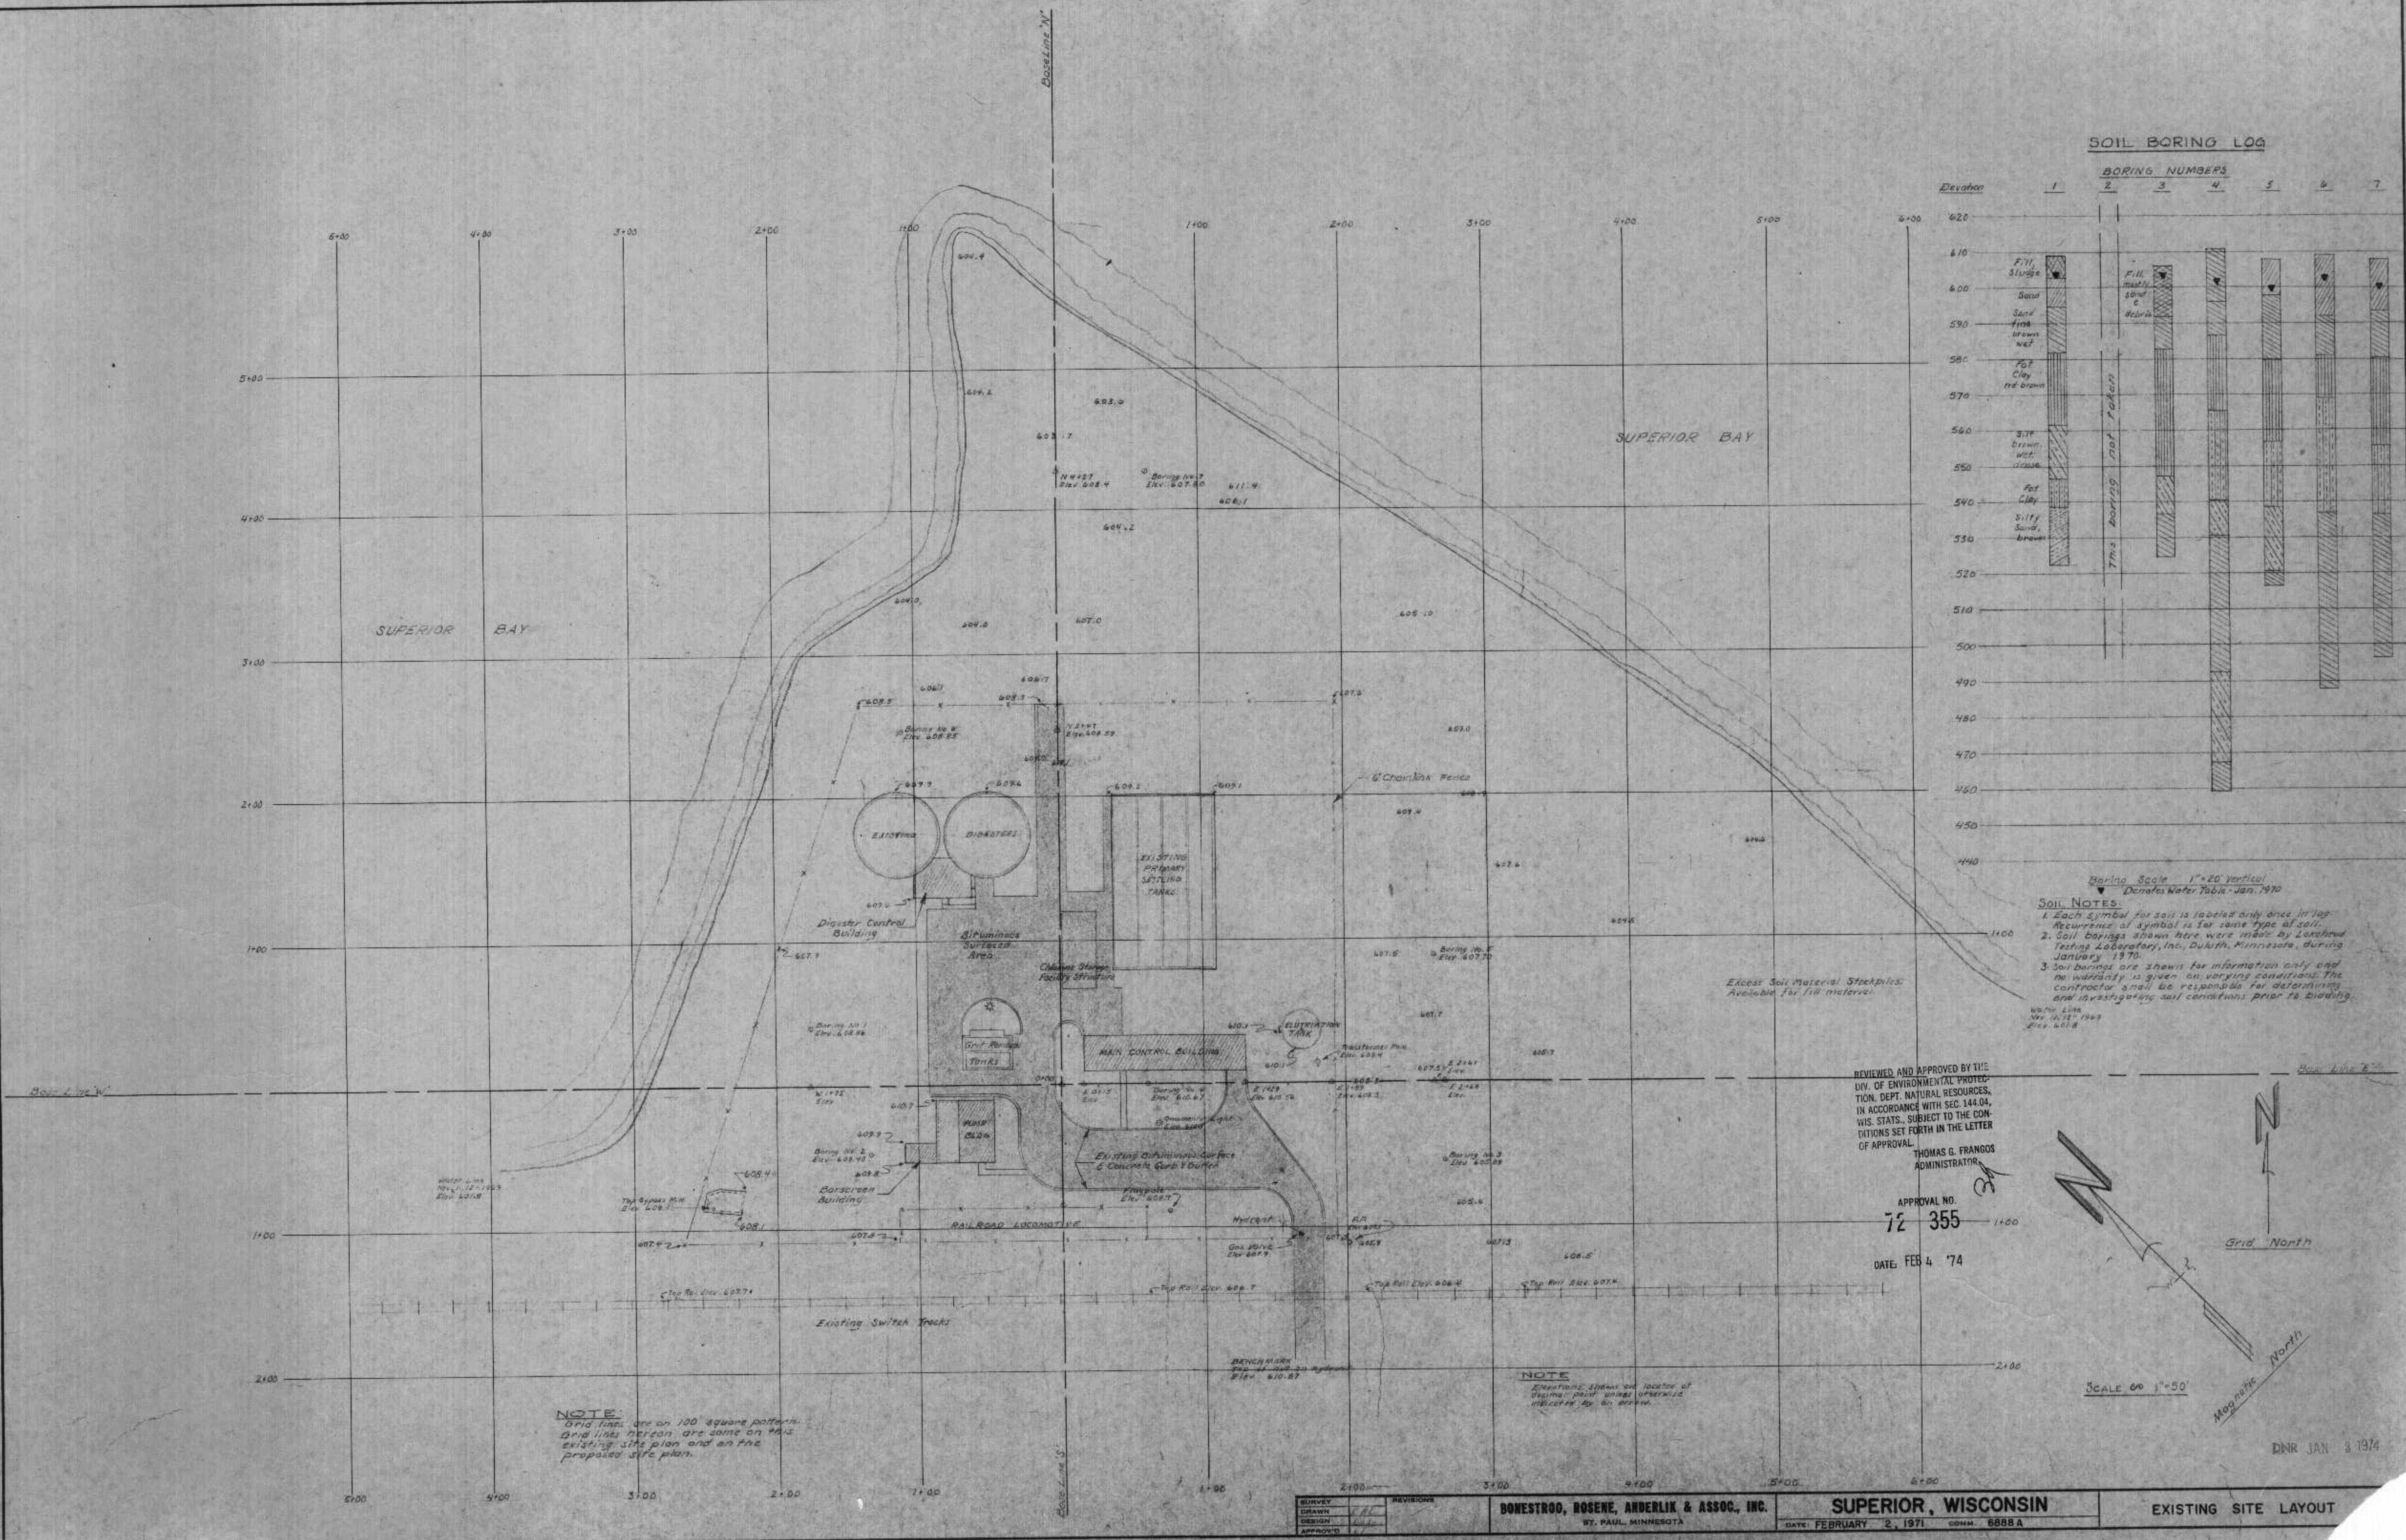

SOIL BORING LOG

Elevation	BORING NUMBERS						
	1	2	3	4	5	6	7
620							
610	F.H. Siltage						
600	Sand						
590	Sands fine brown wet						
580	F.G. Clay red brown						
570							
560	G.T.P. Dense wet yellow						
550							
540	F.F. Clay yellow brown						
530							
520							
510							
0							

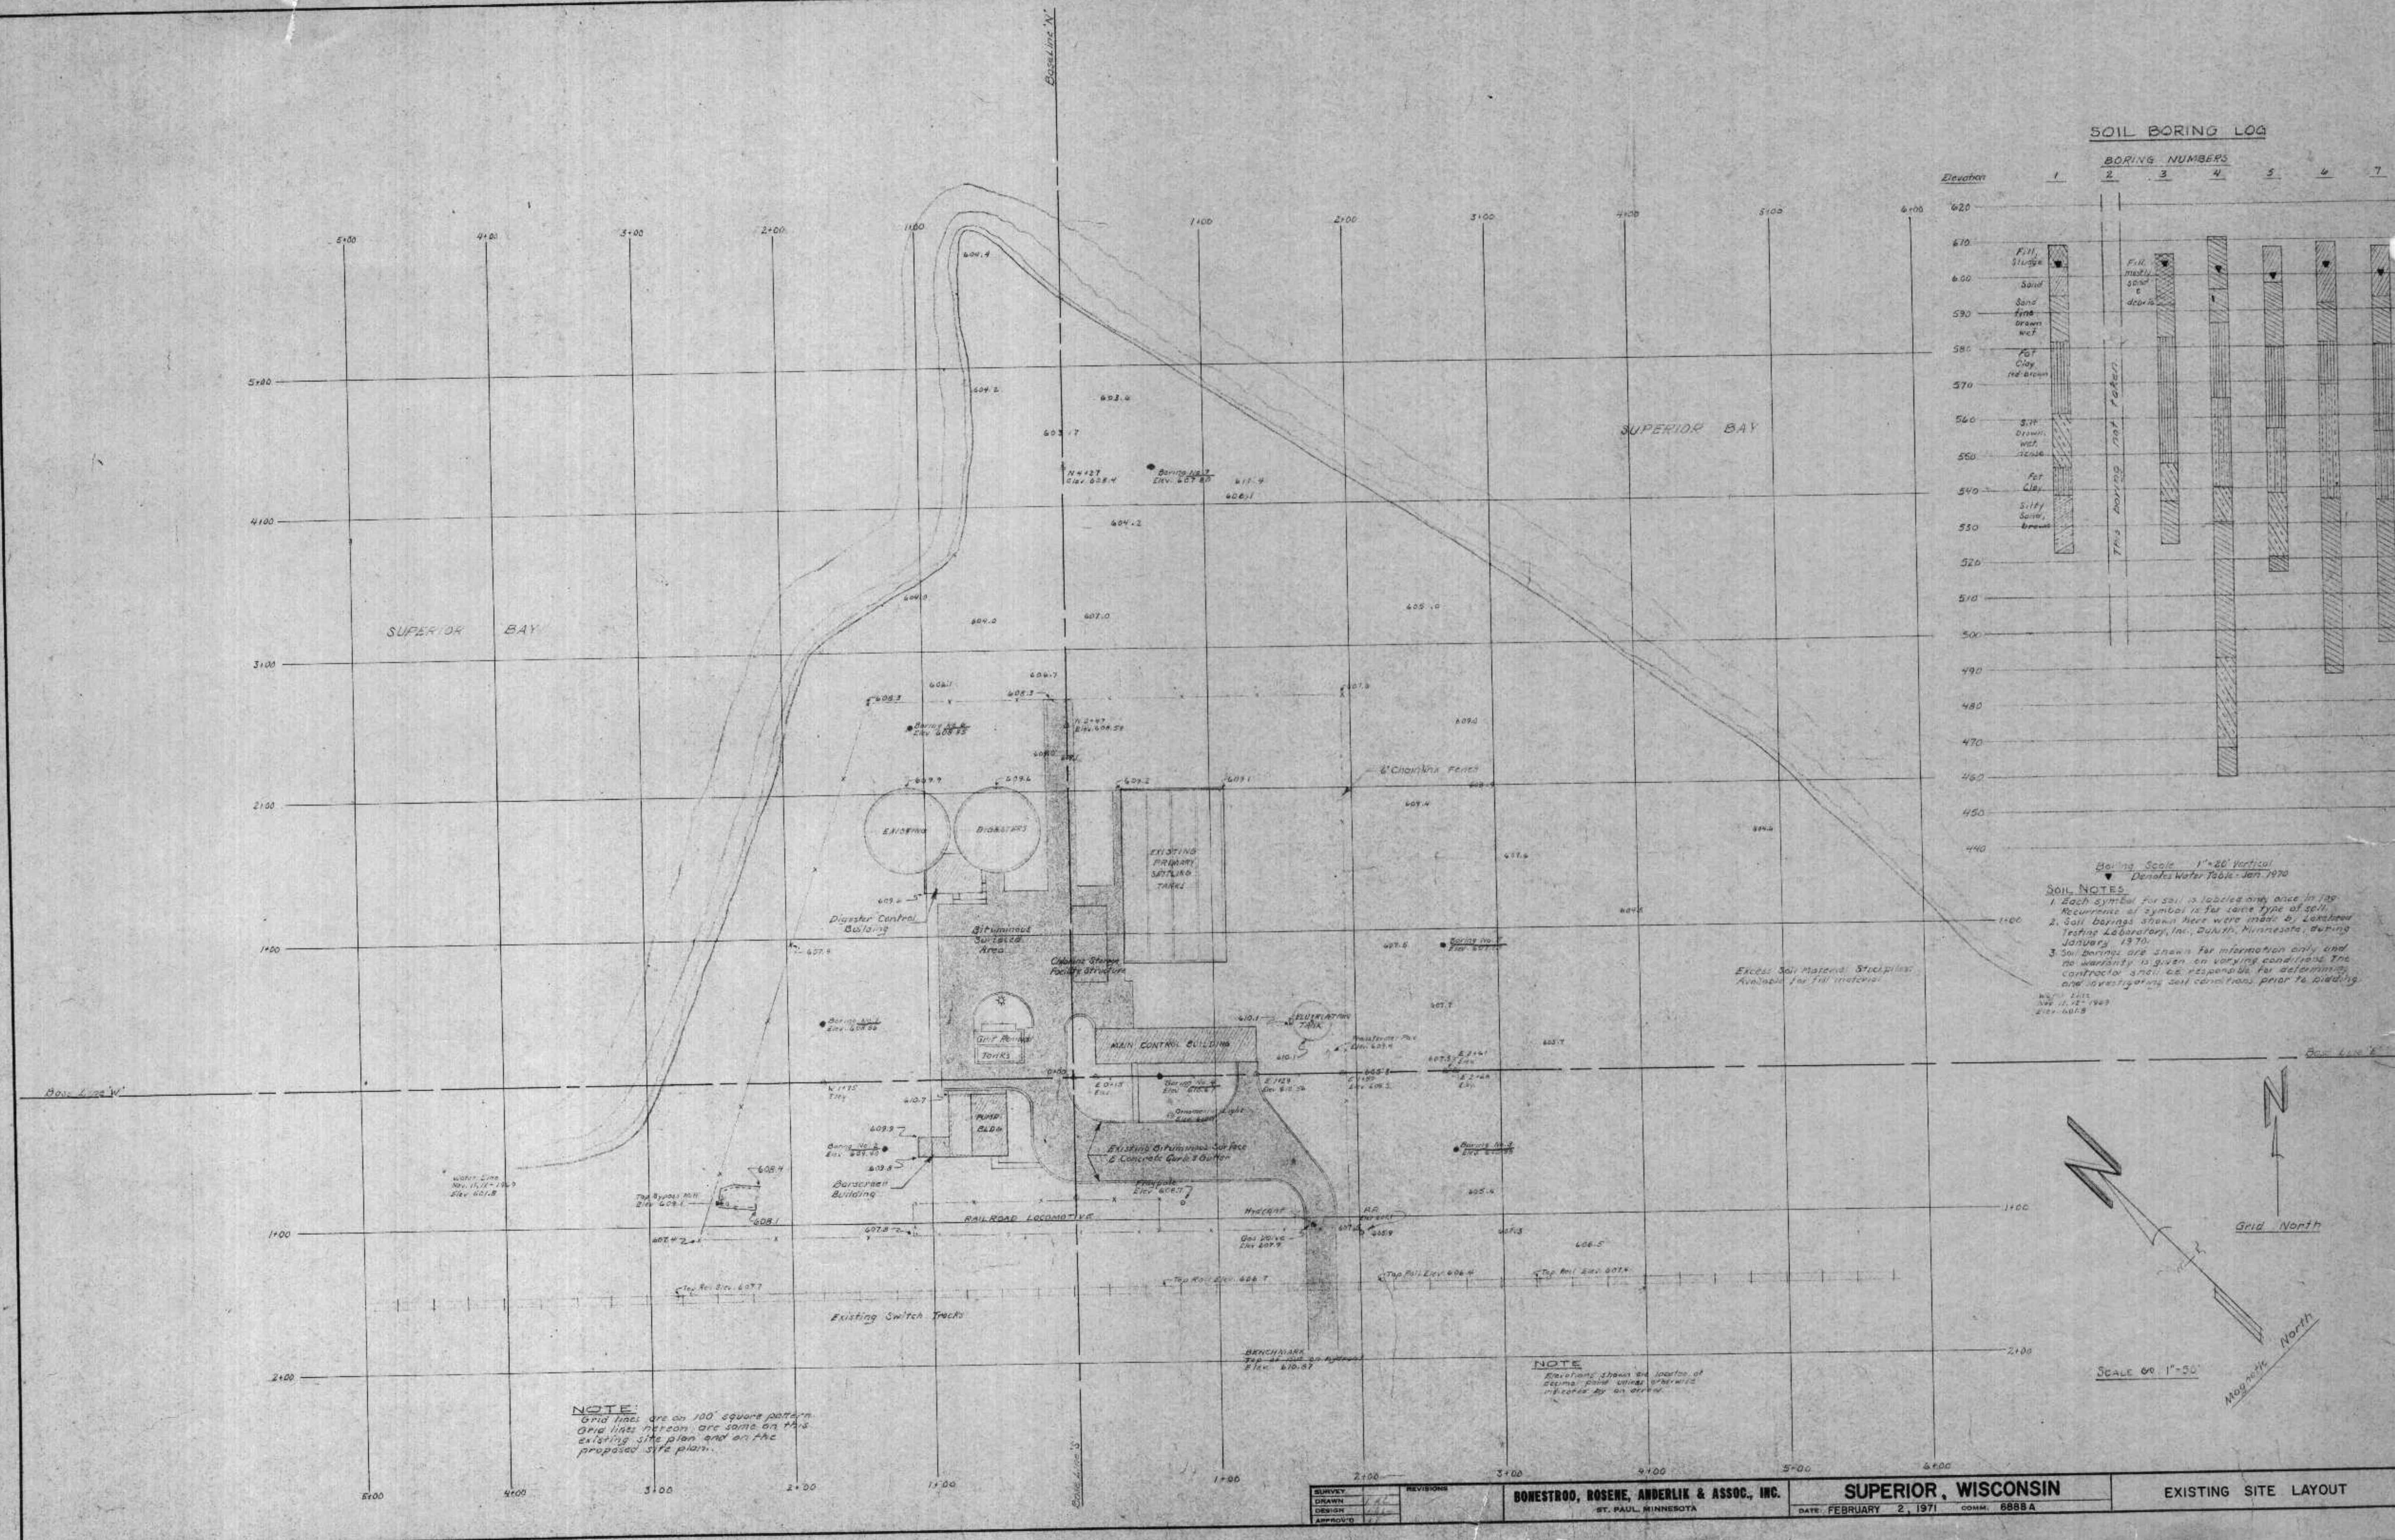



<u>UNIT</u>	<u>POINT</u>	<u>COORDINATES</u>
Primary Settling Tanks	N.E. Cor.	S 0+20, E 3+59
	S.E. Cor.	S 0+39, E 3+39
Aeration Tanks	N.E. Cor.	N 1+32, E 3+23
	N.W. Cor.	N 1+32, E 2+14
Digester	Center	N 2+44, W 1+13
Chlorine Tank No. 1	Center	N 2+71, E 0+76
Chlorine Tank No. 2	Center	N 2+71, E 1+32
Bypass Retention Tank	N.W. Cor.	N 1+45, W 2+01
	N.E. Cor.	N 1+16, W 1+15
Diversion Box A	Locate in Field	
Diversion Box B	Locate in Field	
Filter Coke Storage Silos	N.E. Cor.	N 3+22, W 0+20
	N.W. Cor.	N 3+22, W 1+00

NOTE
Grid lines shown on 100' square grid
table above give grid coordinates for
location of proposed units. See
separate drawings for dimensions of
each unit. Check all locations carefully
in field. Some unit locations may require
minor change as directed by the Engineer.

Existing Fence - Leave as is	x	x
New 6' H scalloped fence	x	x
Existing Fence Line + 3' extension	-	-
Existing 3' high	star	Power Pole ♀
Existing Posts	△ E 1129 (Station on baseline)	
Existing Structure	[]	
Proposed Structure	[]	
Existing Rooted Edge	[]	
Proposed Rooted Edge	[]	
Existing Bituminous Surface	[]	
Proposed Bituminous Surface	[]	
Existing Concrete Sidewalk	[]	
Proposed 4" Concrete Sidewalk	[]	
Proposed 16" x 16" shareline post/pillar	[]	

LEGEND
SYMBOLS

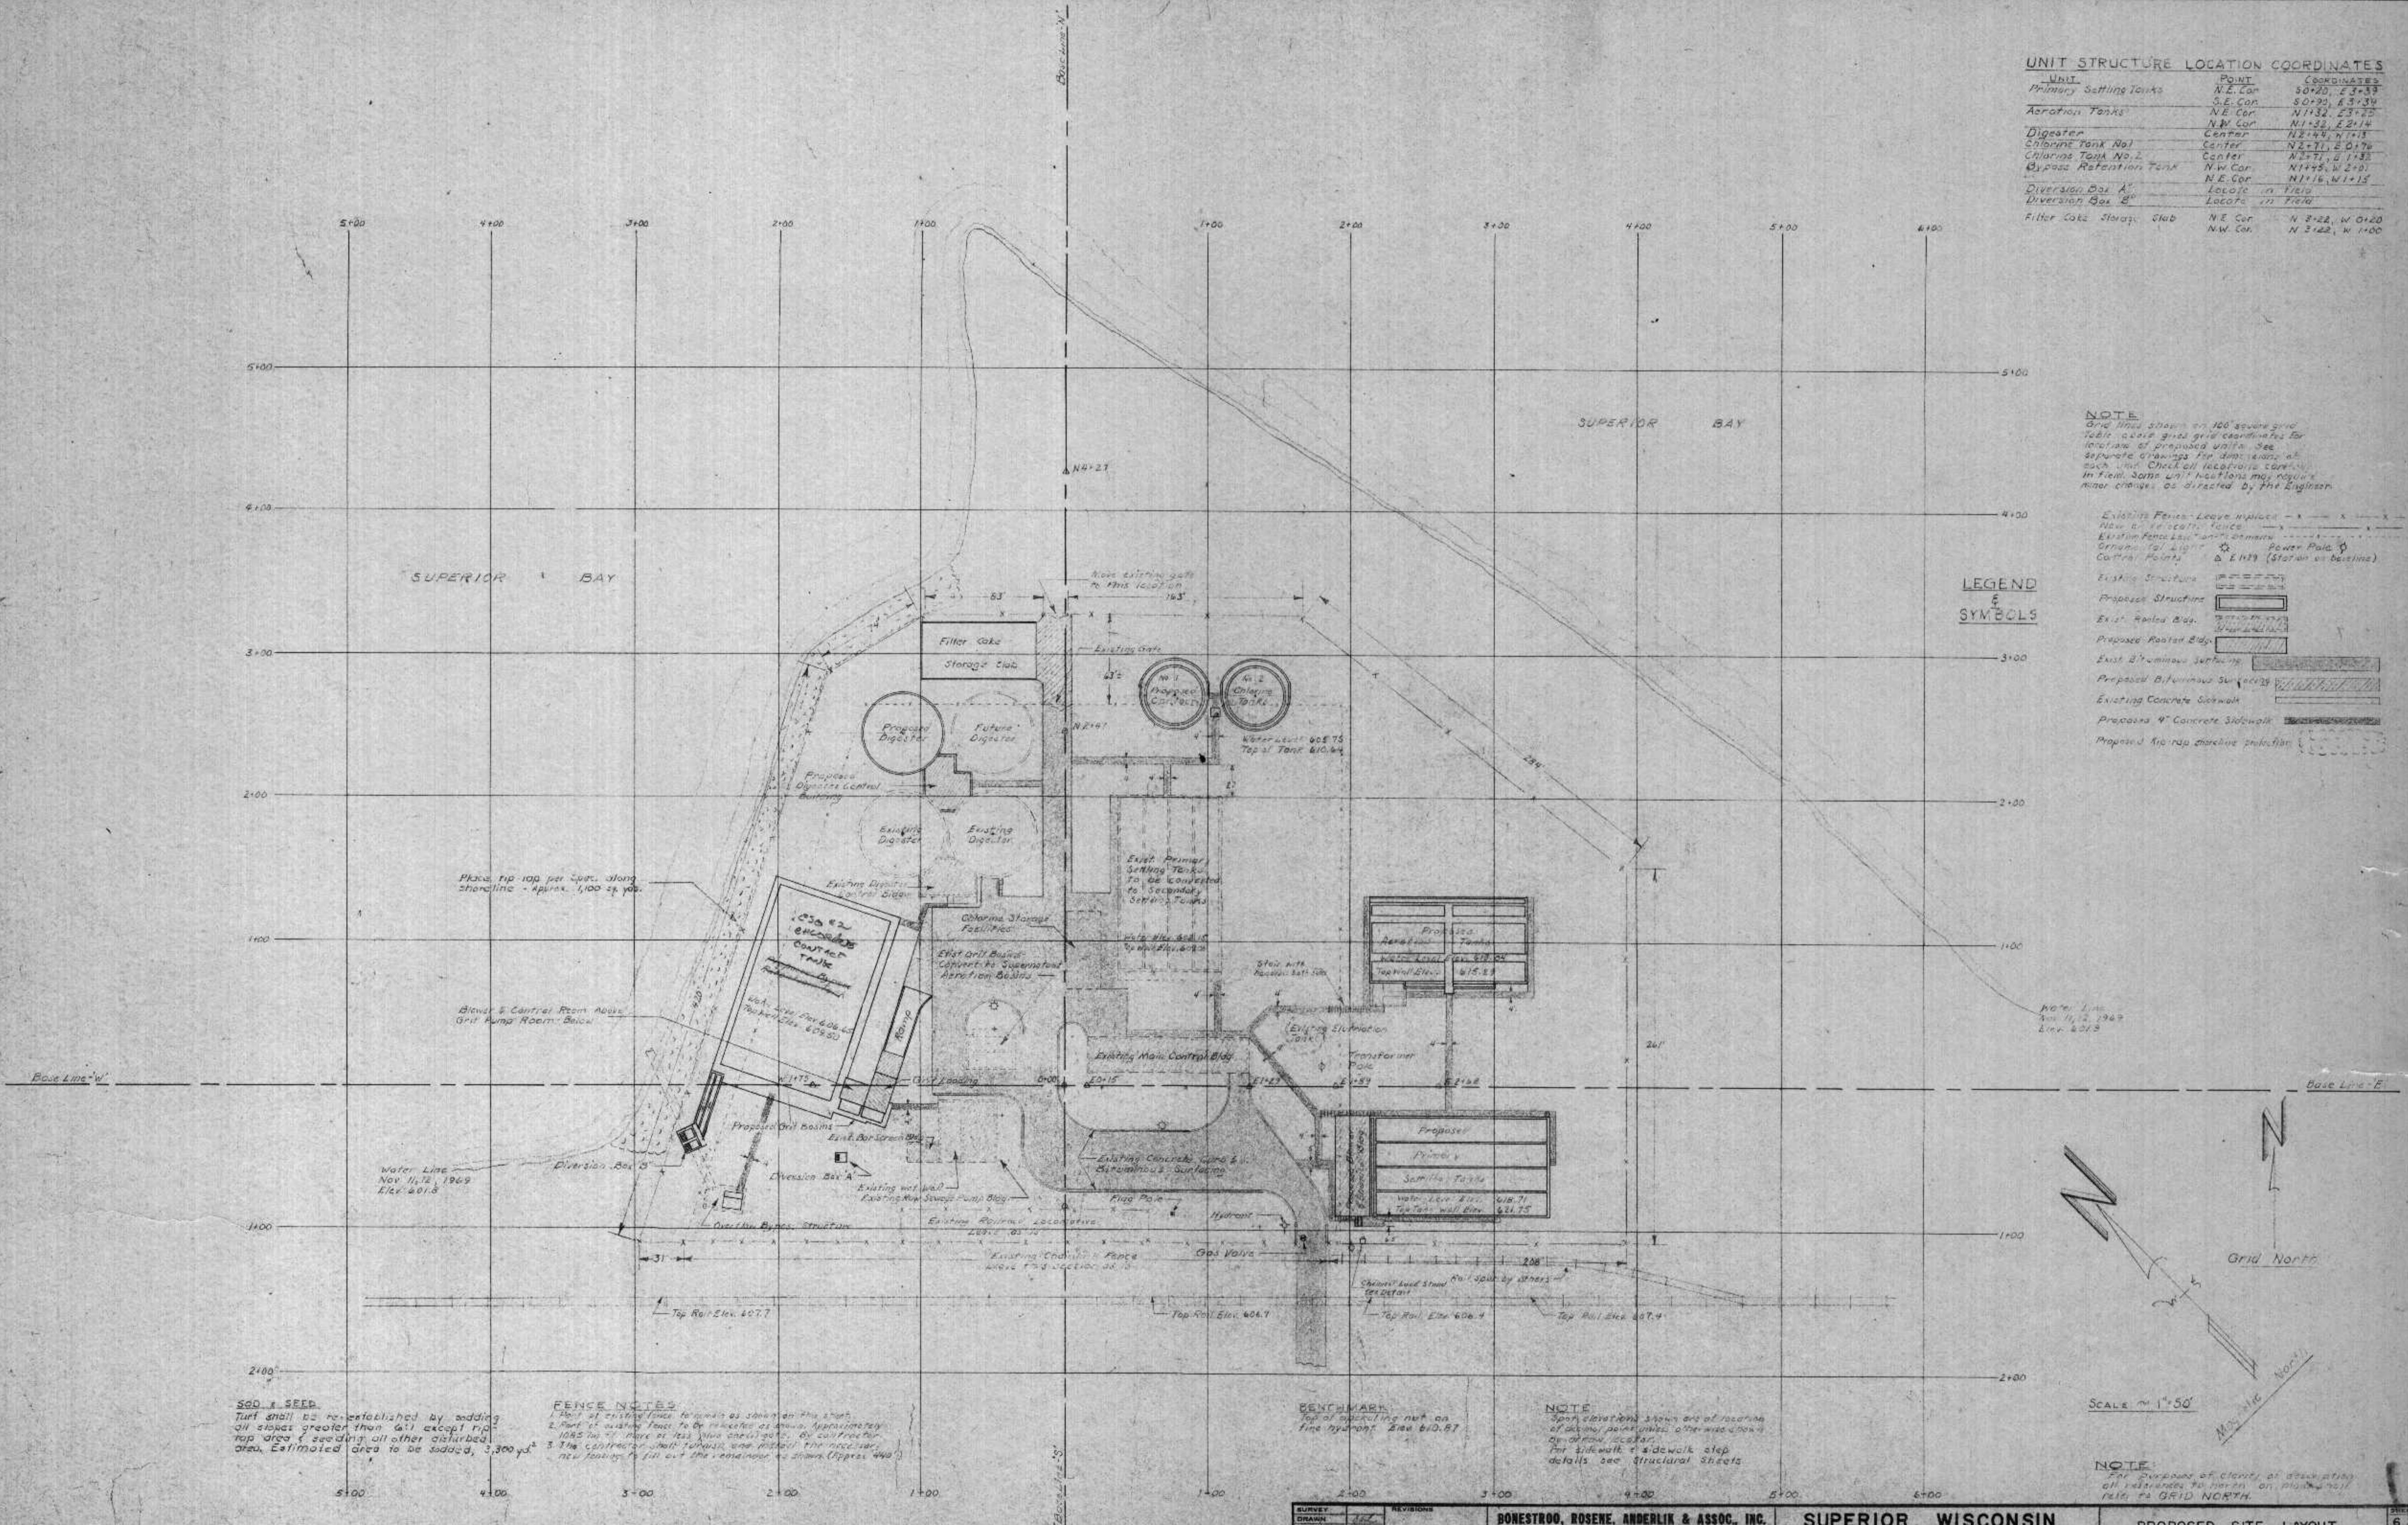

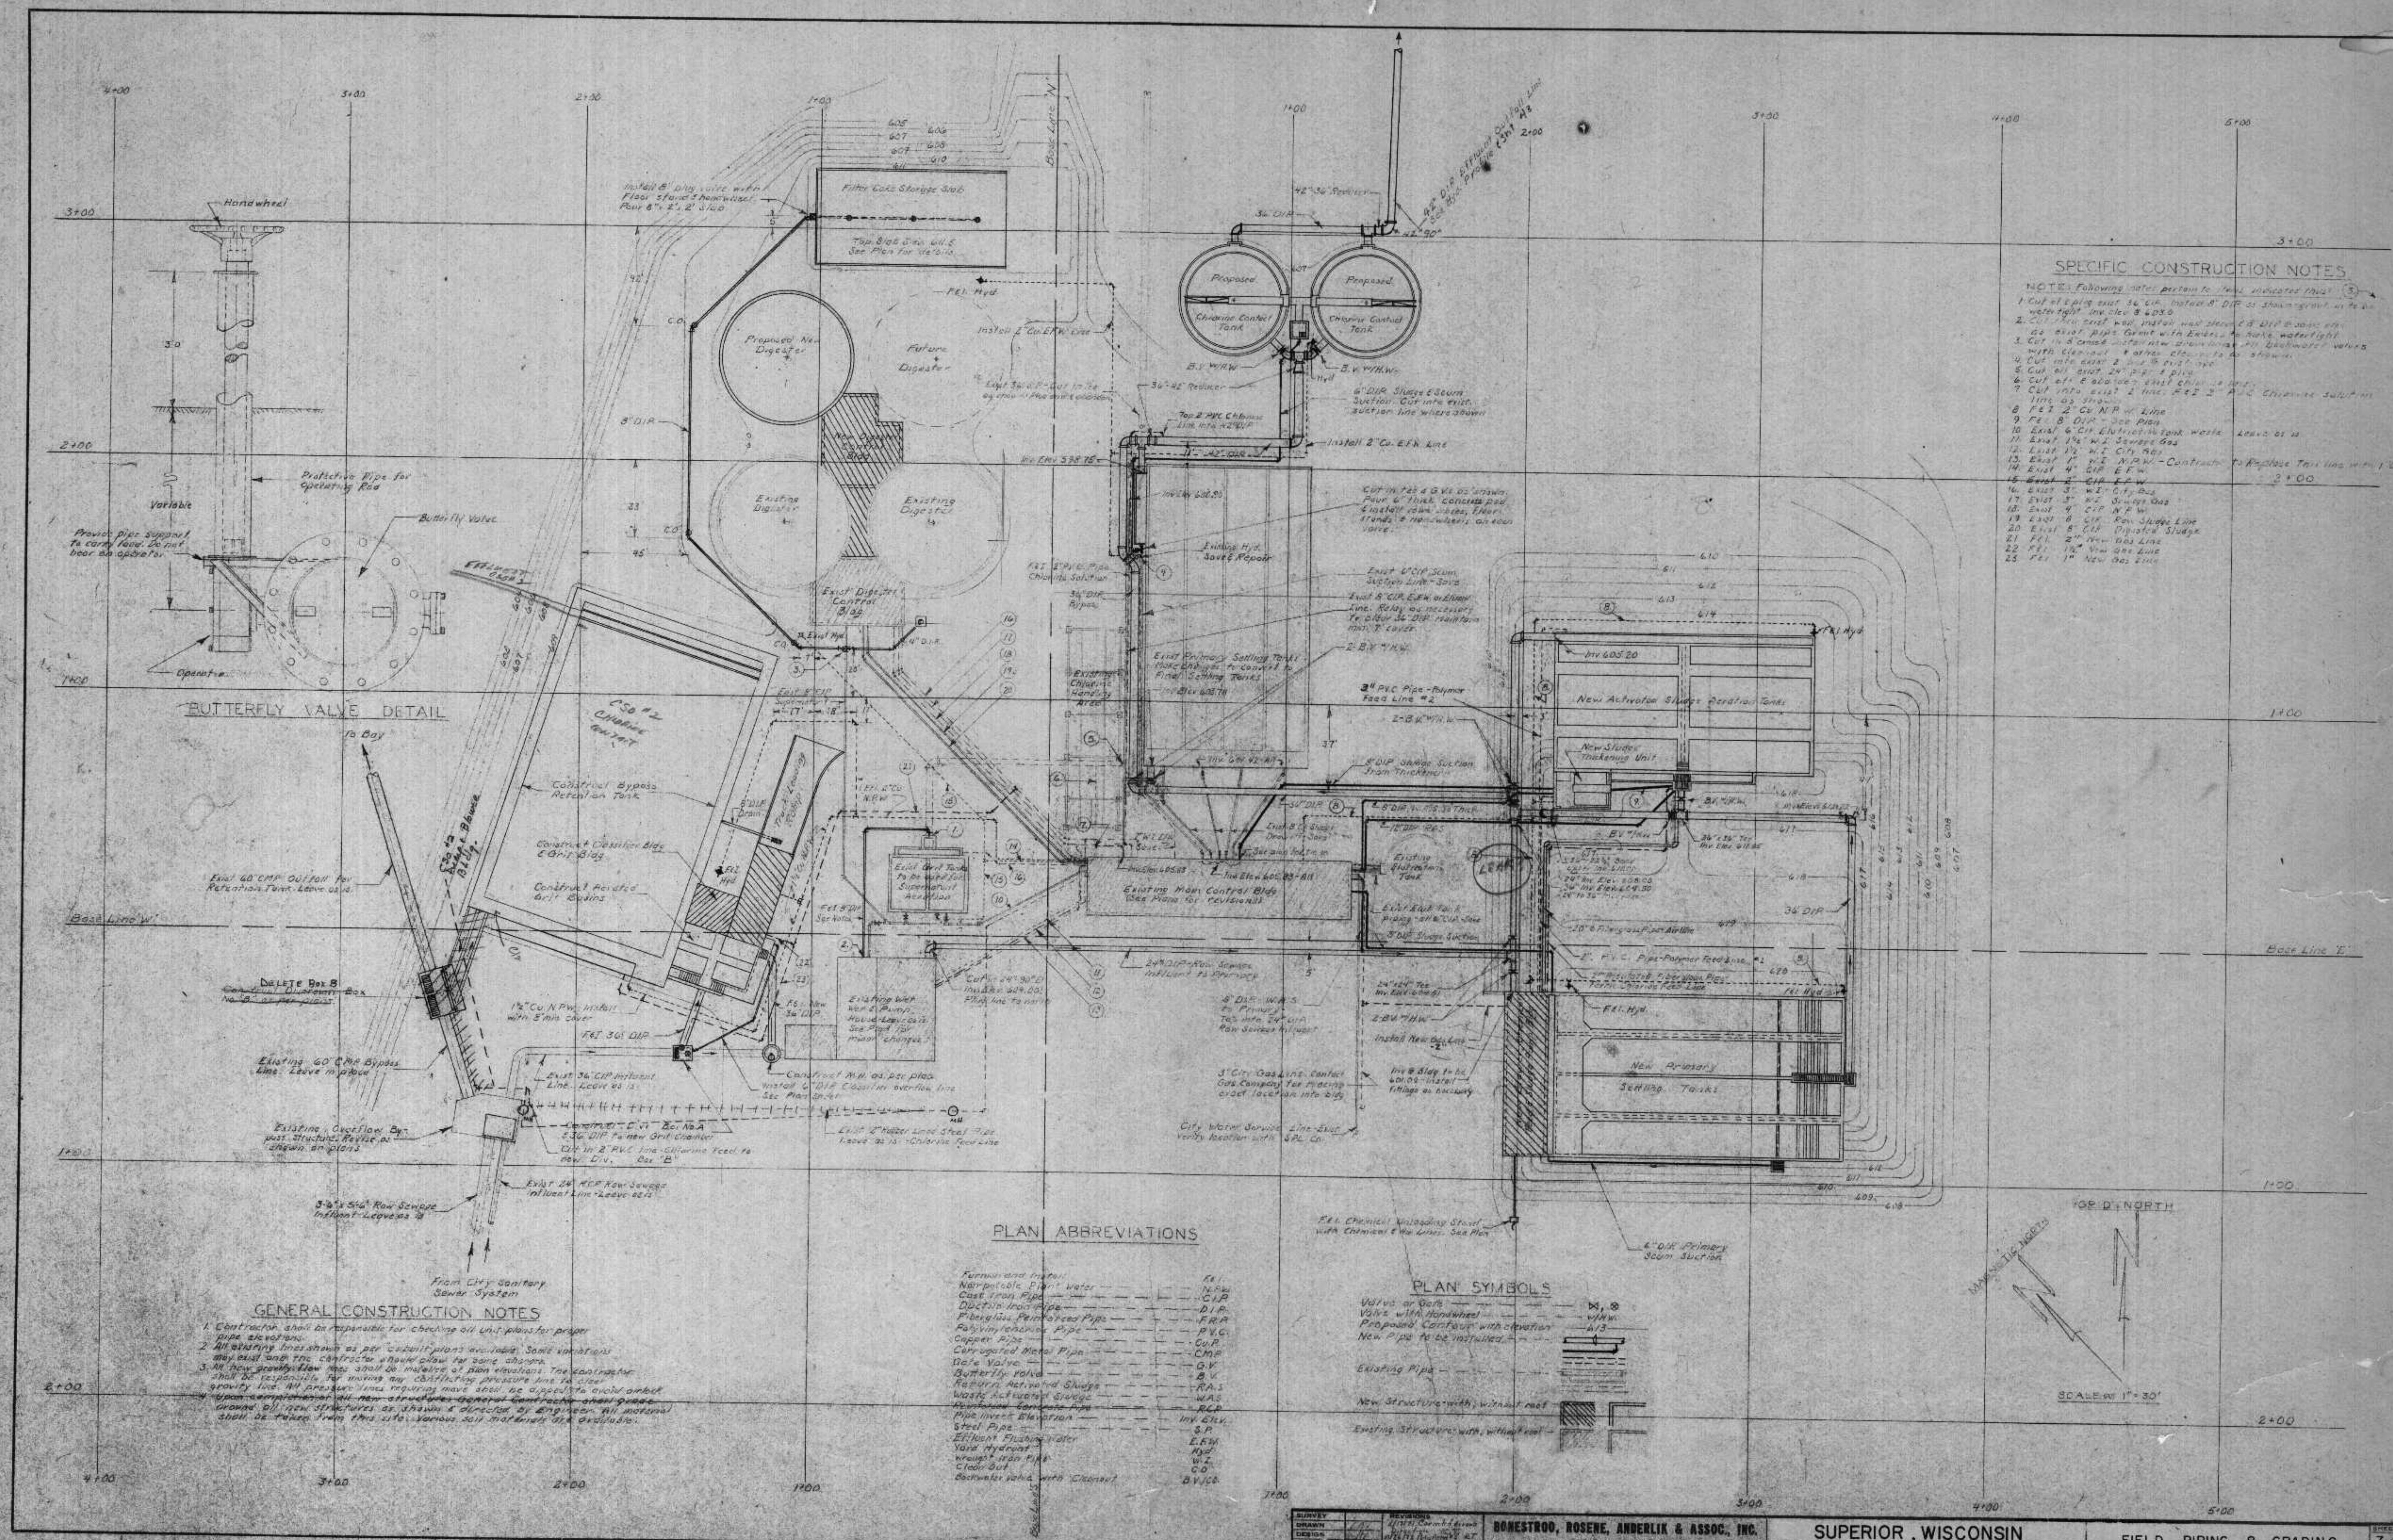

PLAN | ABBREVIATIONS


Furnace and motor	
Narrowable Plant Water	
Cast Iron Pipe	
Ductile Iron Pipe	
Fiberglass Reinforced Pipe	
Polyvinyl Chloride Pipe	
Copper Pipe	
Corrugated Metal Pipe	
Gate Valve	
Butterfly Valve	
Return Activated Sludge	
Waste Activated Sludge	
Reinforced Concrete Pipe	
Pipe Invert Elevation	
Steel Pipe	
Effluent Flushing Meter	
Yard Hydrant	
wrought iron pipe	
Clean Out	
Backwater valve with Cleanout	

PLAN SYMBOLS

BONESTROO, ROSENE, ANDERLIK & ASSOC., INC.
ST. PAUL, MINNESOTA

SUPERIOR, WISCONSIN
FEBRUARY 3, 1971

FIELD PIPING & GRADING

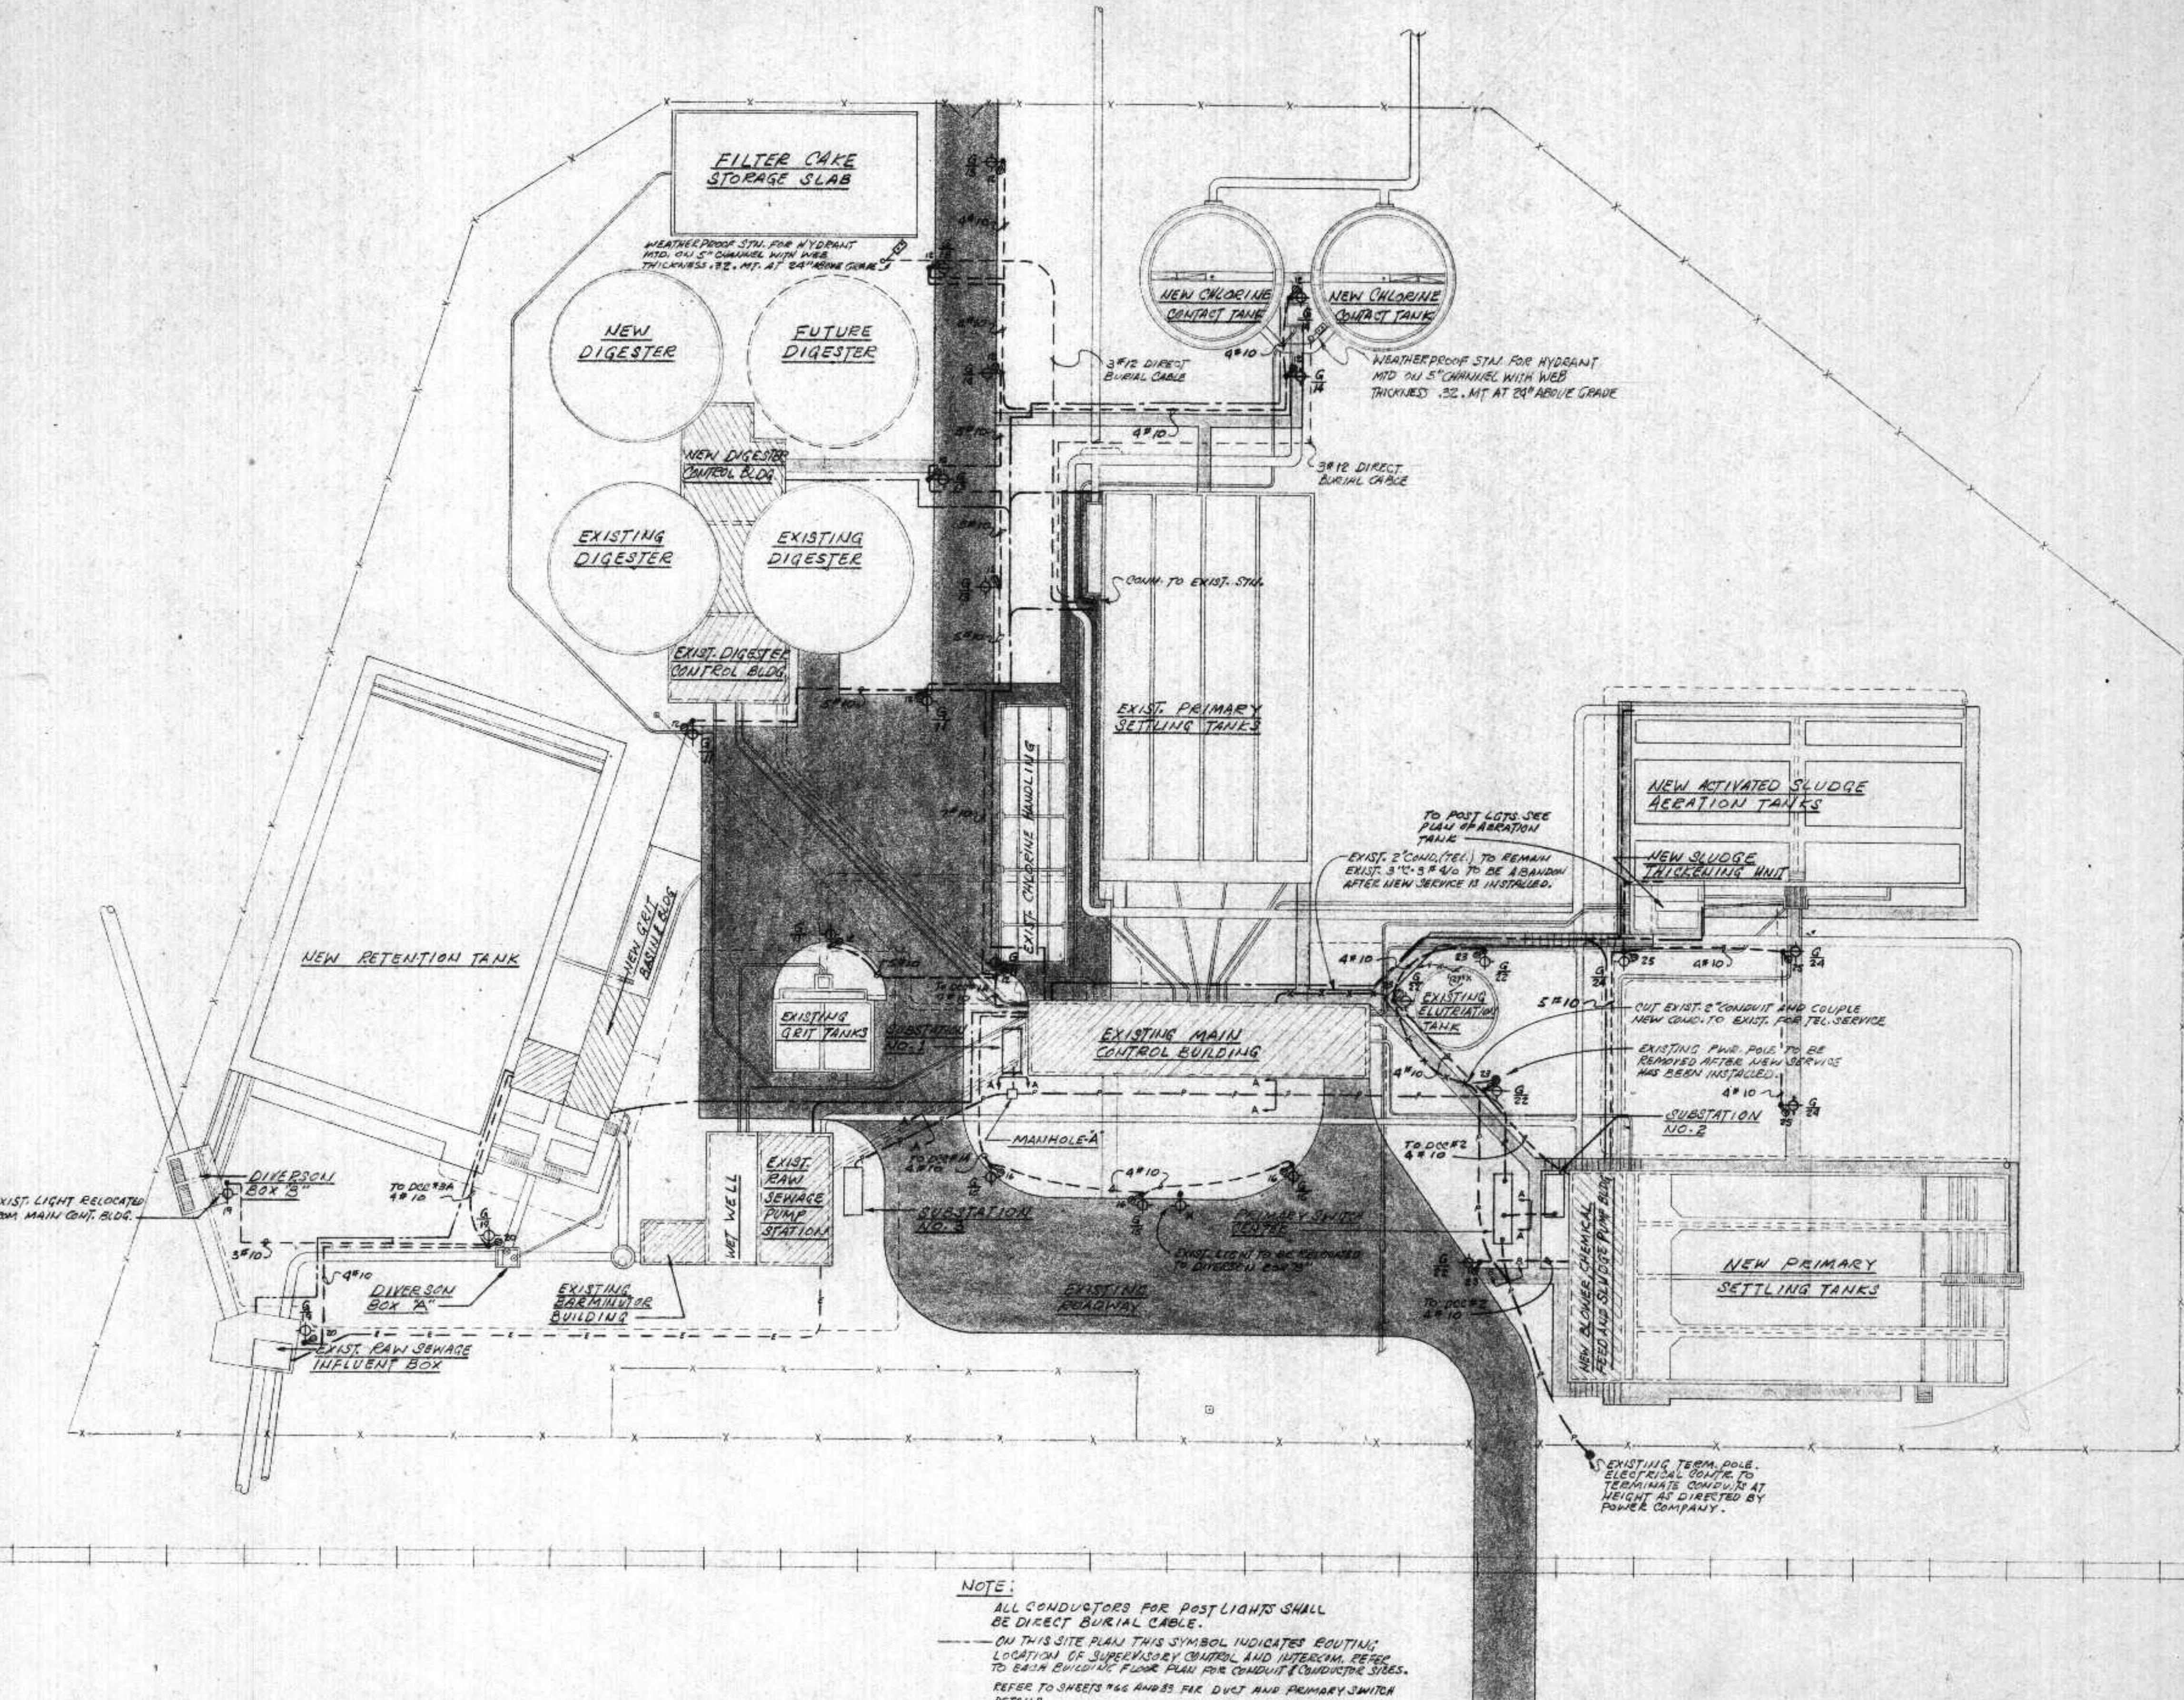

I HEREBY CERTIFY THAT THIS PLAN WAS PREPARED BY ME OR UNDER
MY DIRECT SUPERVISION AND THAT I AM A DULY REGISTERED
ENGINEER UNDER LAW OF THE STATE OF MINNESOTA
P. Ellison
DATE: REG. NO. 4713

ERICKSEN ELLISON AND ASSOC. INC.
ST PAUL, MINNESOTA


SURVEY
DRAWN
DESIGN
APPROVED

REVISIONS
8/17/71 TT
BONESTROO, ROSENE, ANDERLIK & ASSOC., INC.
ST. PAUL, MINNESOTA


DATE: FEBRUARY 2, 1971 COMM. 6888A
SUPERIOR, WISCONSIN

SITE PLAN

SHEET
65
84

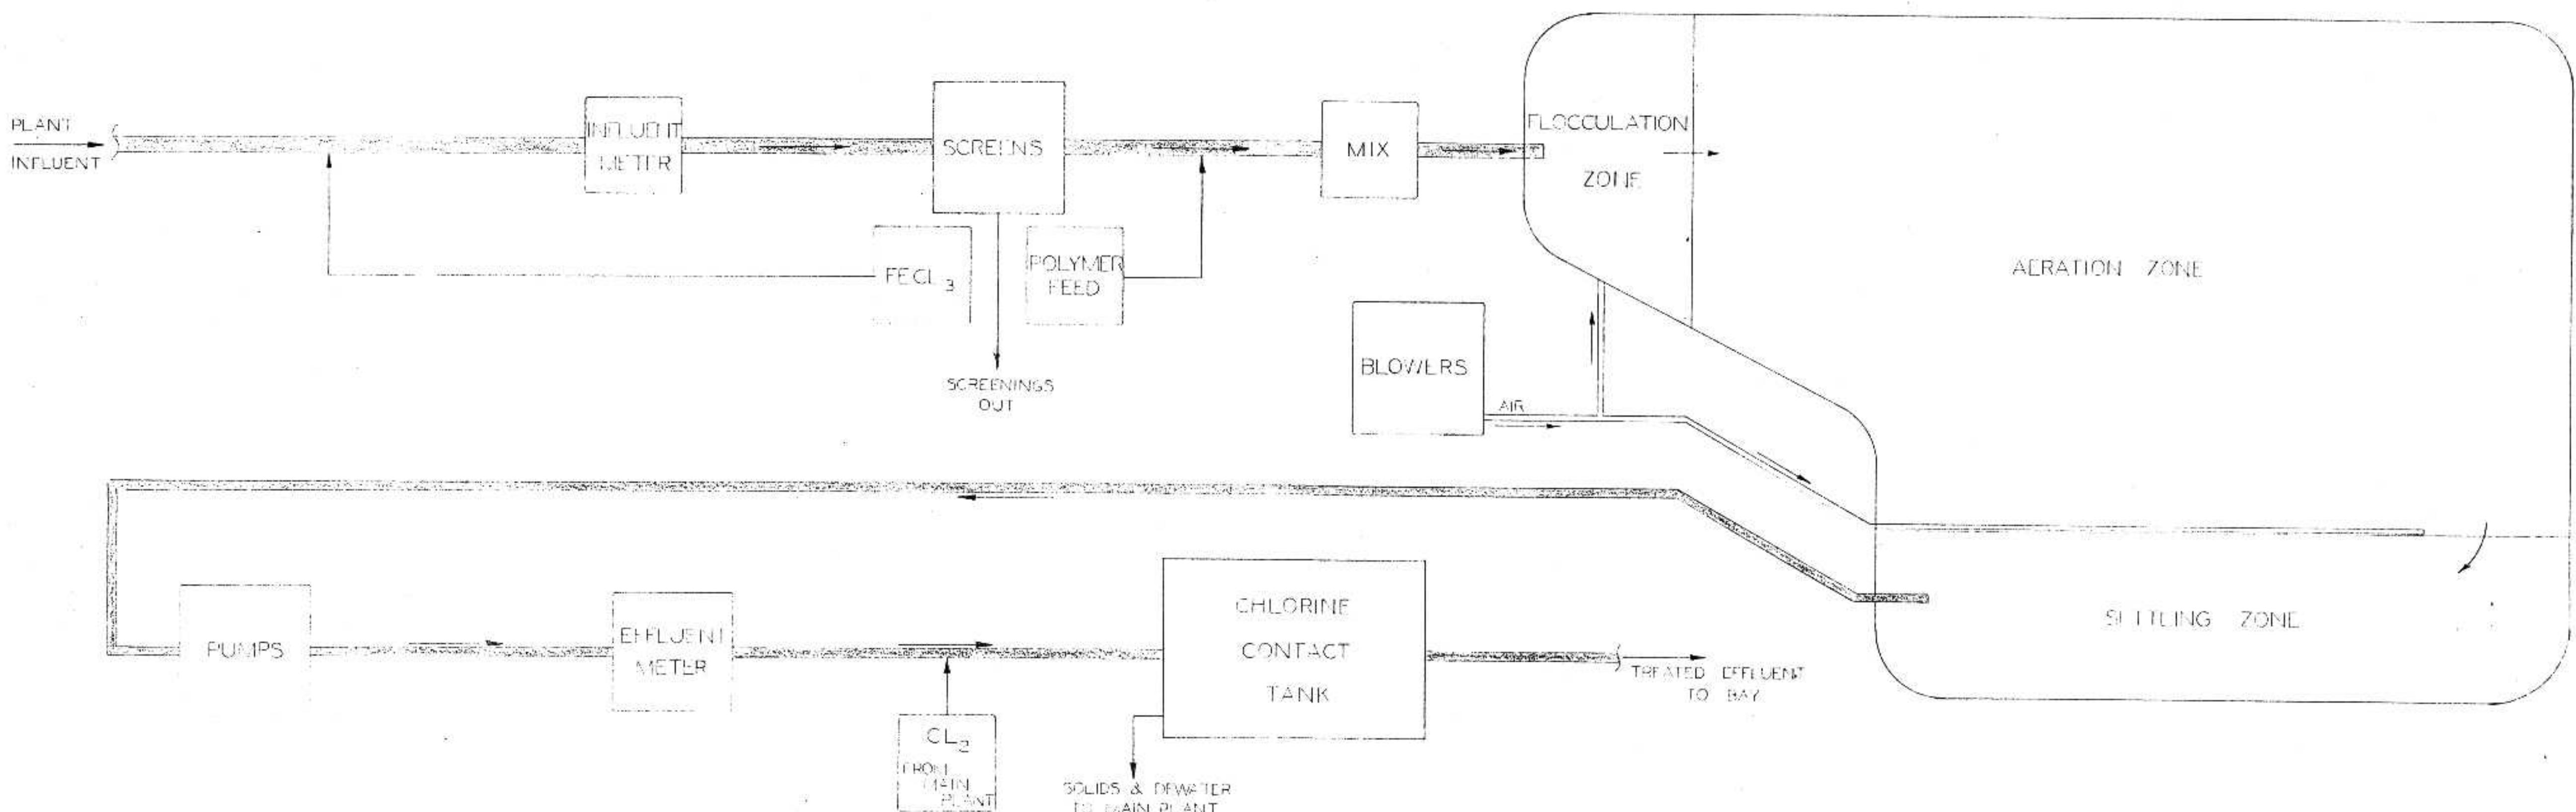

FLOW DIAGRAM

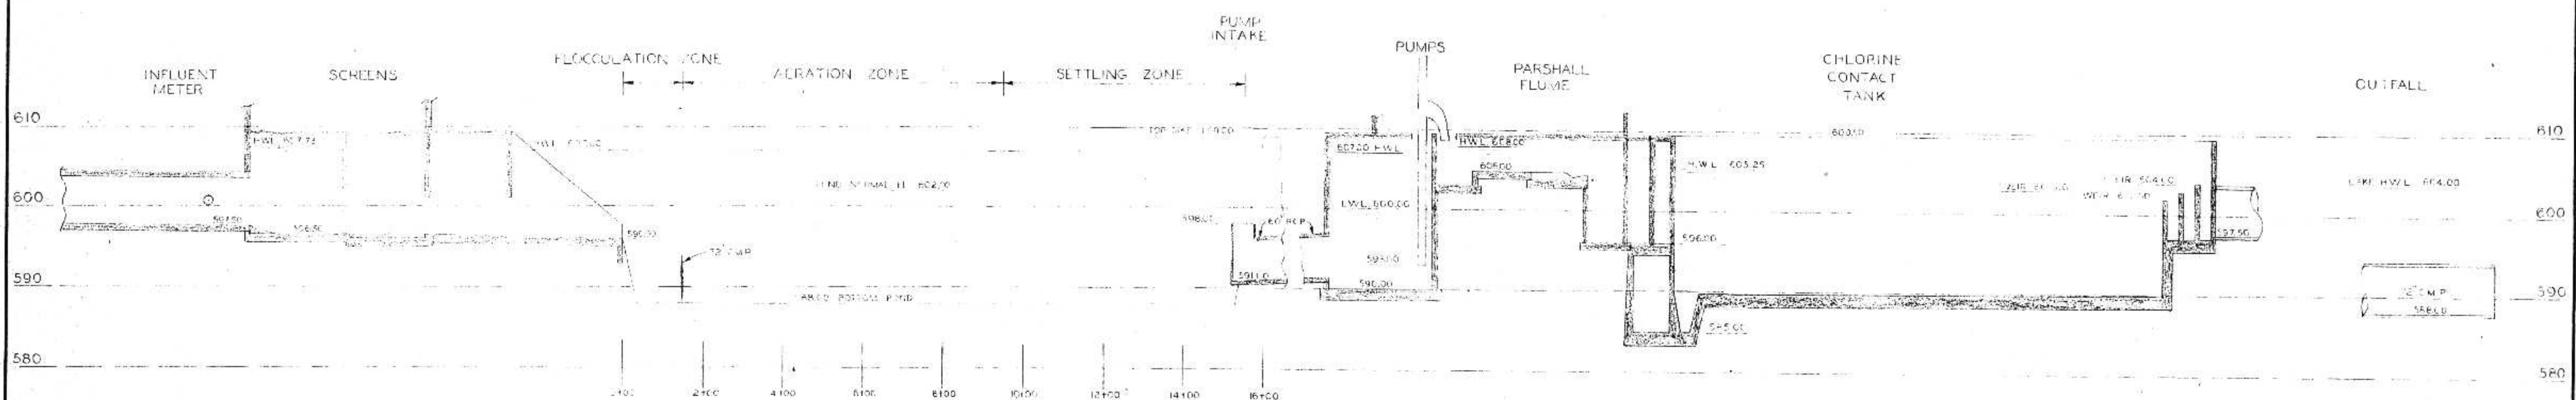

HYDRAULIC PROFIL

HORIZ. $I' = 20'$
VERT $I' = 10'$
UNLESS NOTED OTHERWISE


I HEREBY CERTIFY THAT THIS PLAN WAS PREPARED
ON BEHALF OF THE CITY OF MILWAUKEE AND THAT I AM
REGISTERED PROFESSIONAL ENGINEER UNDER THE LA
THE STATE OF WISCONSIN


SURVEY	GRC
DRAWN	DCB
DESIGN	RFT
APPROVED	RFT

BONESTROO, ROSENE, ANDERLIK & ASSOC.
ST. PAUL, MINNESOTA

SUPERIOR, WISCONSIN


CONSIN C. S. O. PLANT - DISTRICT 2
FLOW DIAGRAM & HYDRAULIC PROFILE

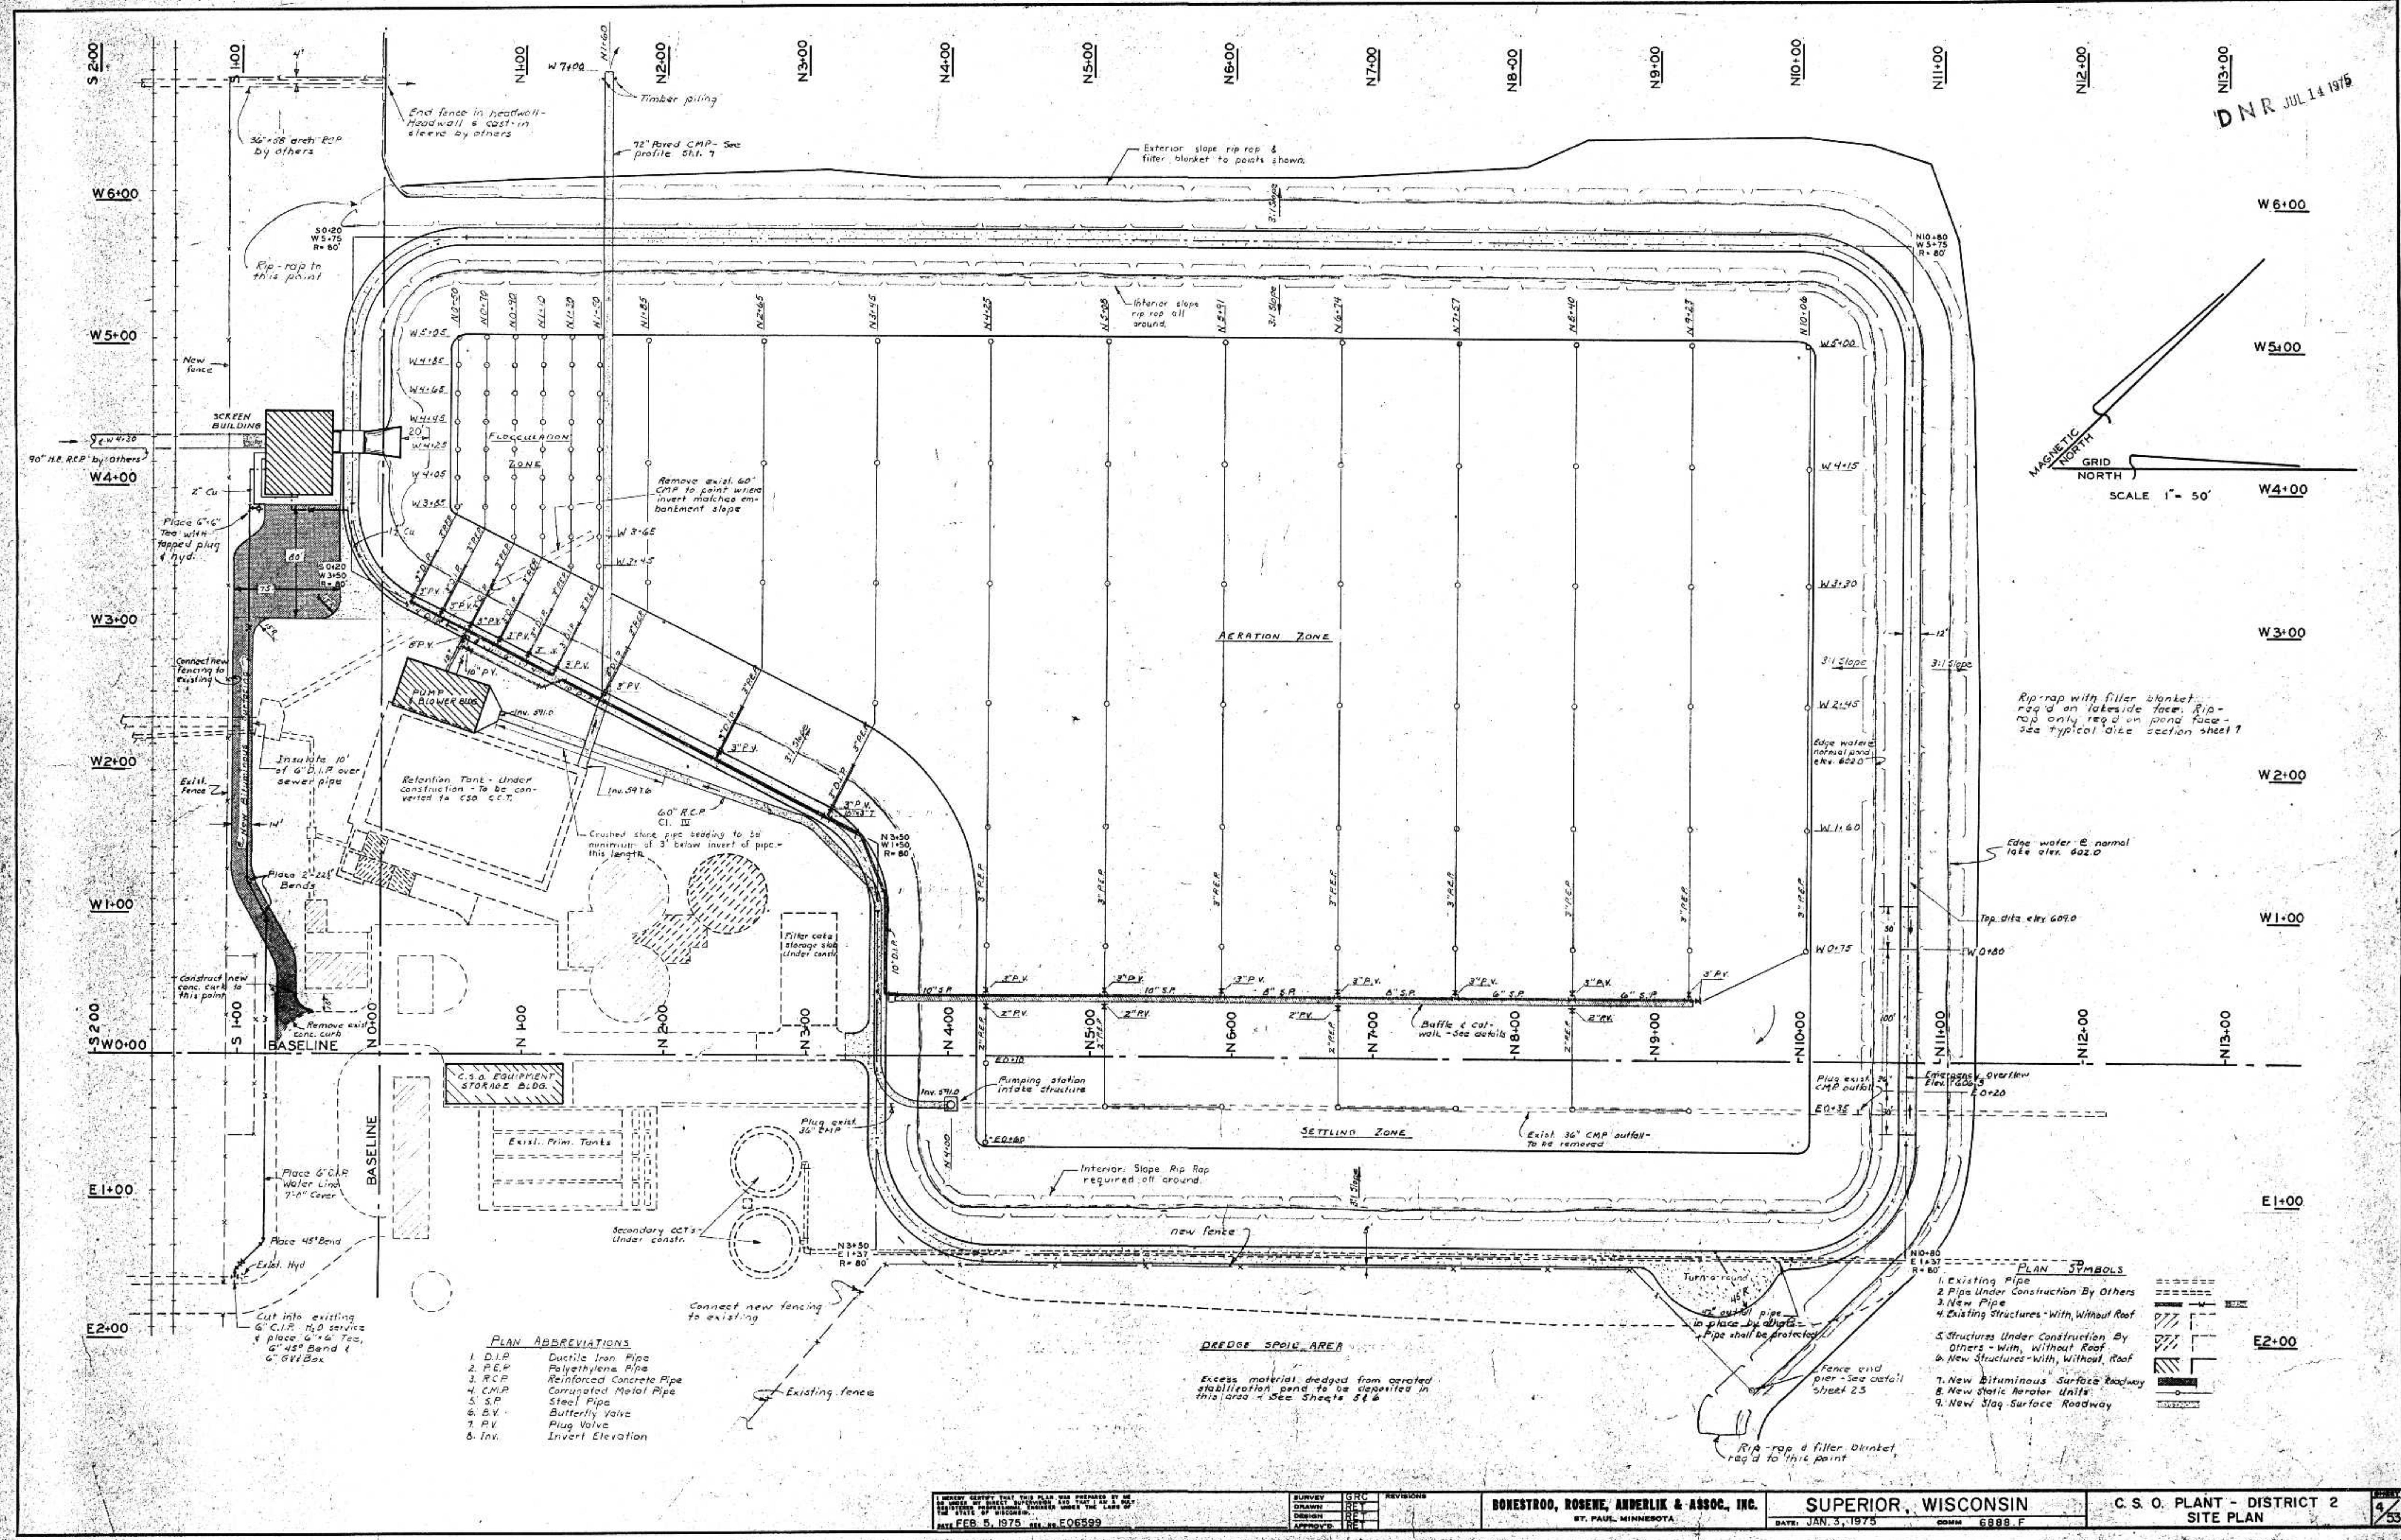

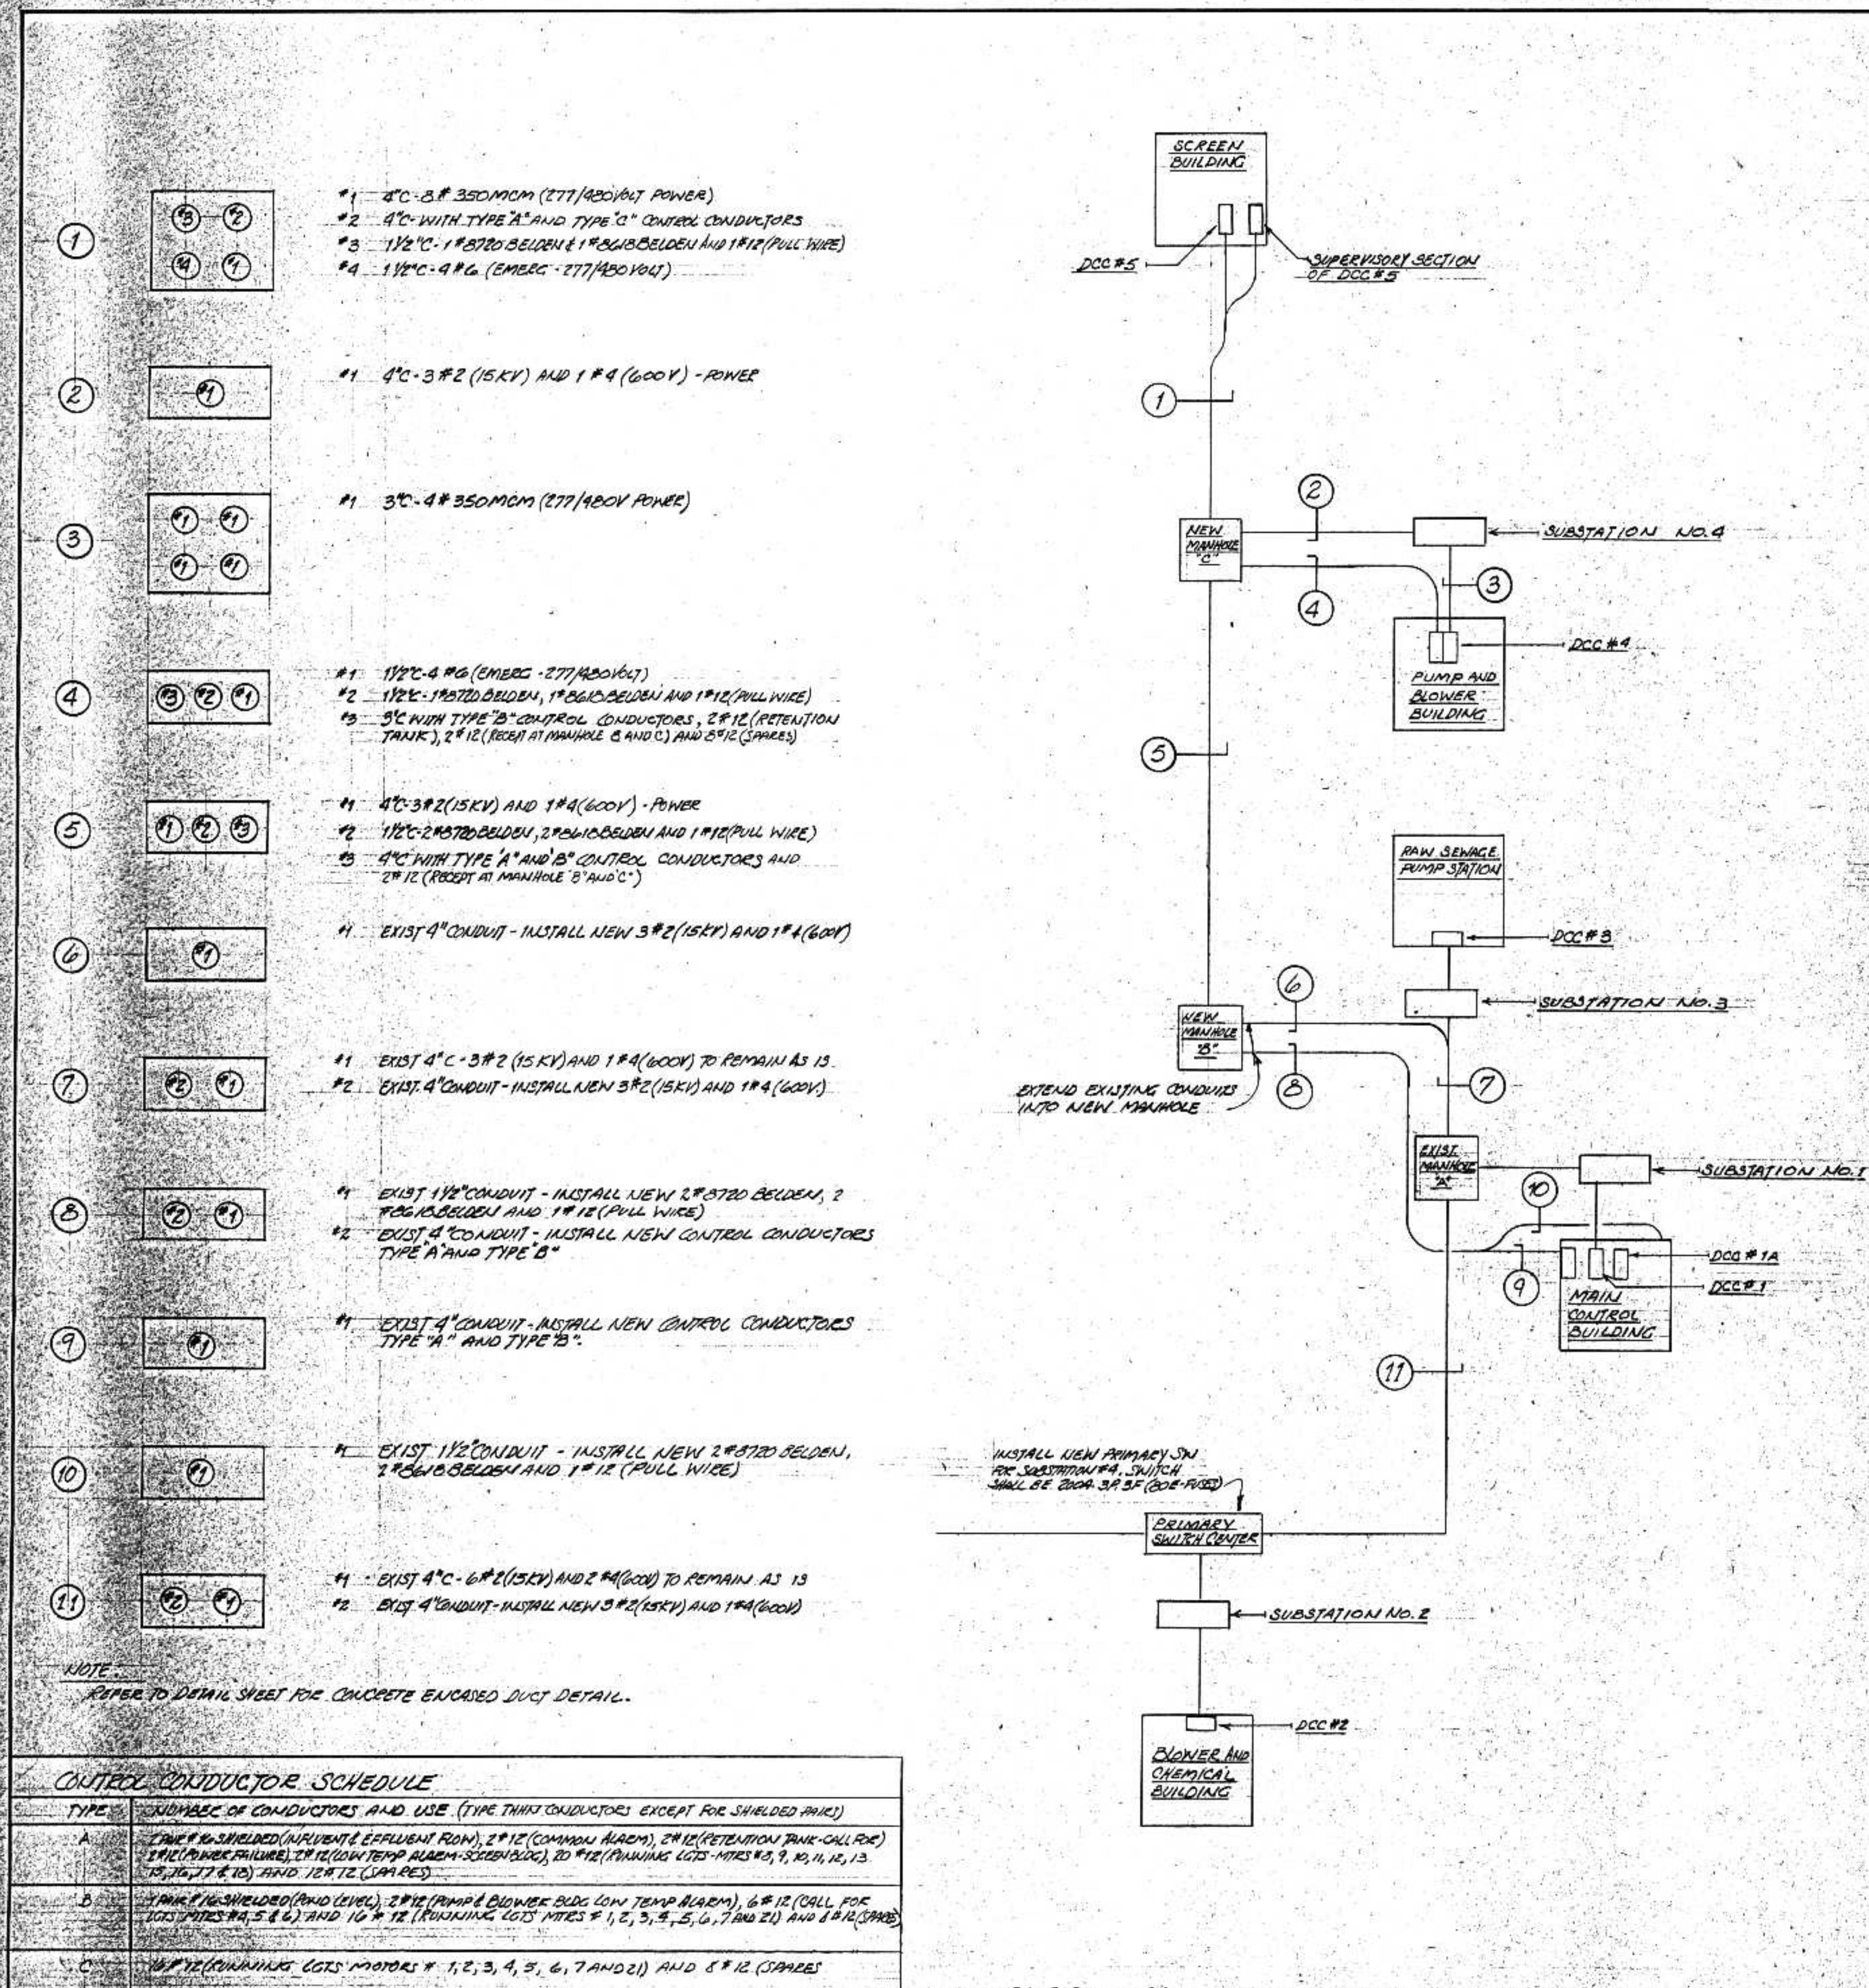



ELECTRICAL UNDERGROUND SCHEMATIC

NPS

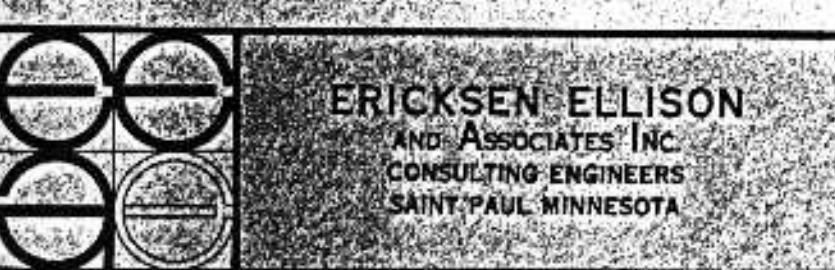

ERICKSEN ELLISON
AND ASSOCIATES INC.
CONSULTING ENGINEERS
SAINT PAUL, MINNESOTA

I HEREBY CERTIFY THAT THIS PLAN WAS PREPARED BY AN
REGISTERED PROFESSIONAL ENGINEER UNDER THE LAW OF
THE STATE OF MINNESOTA
DATE JUNE 14 1975
F15569 *John H. Hansen*

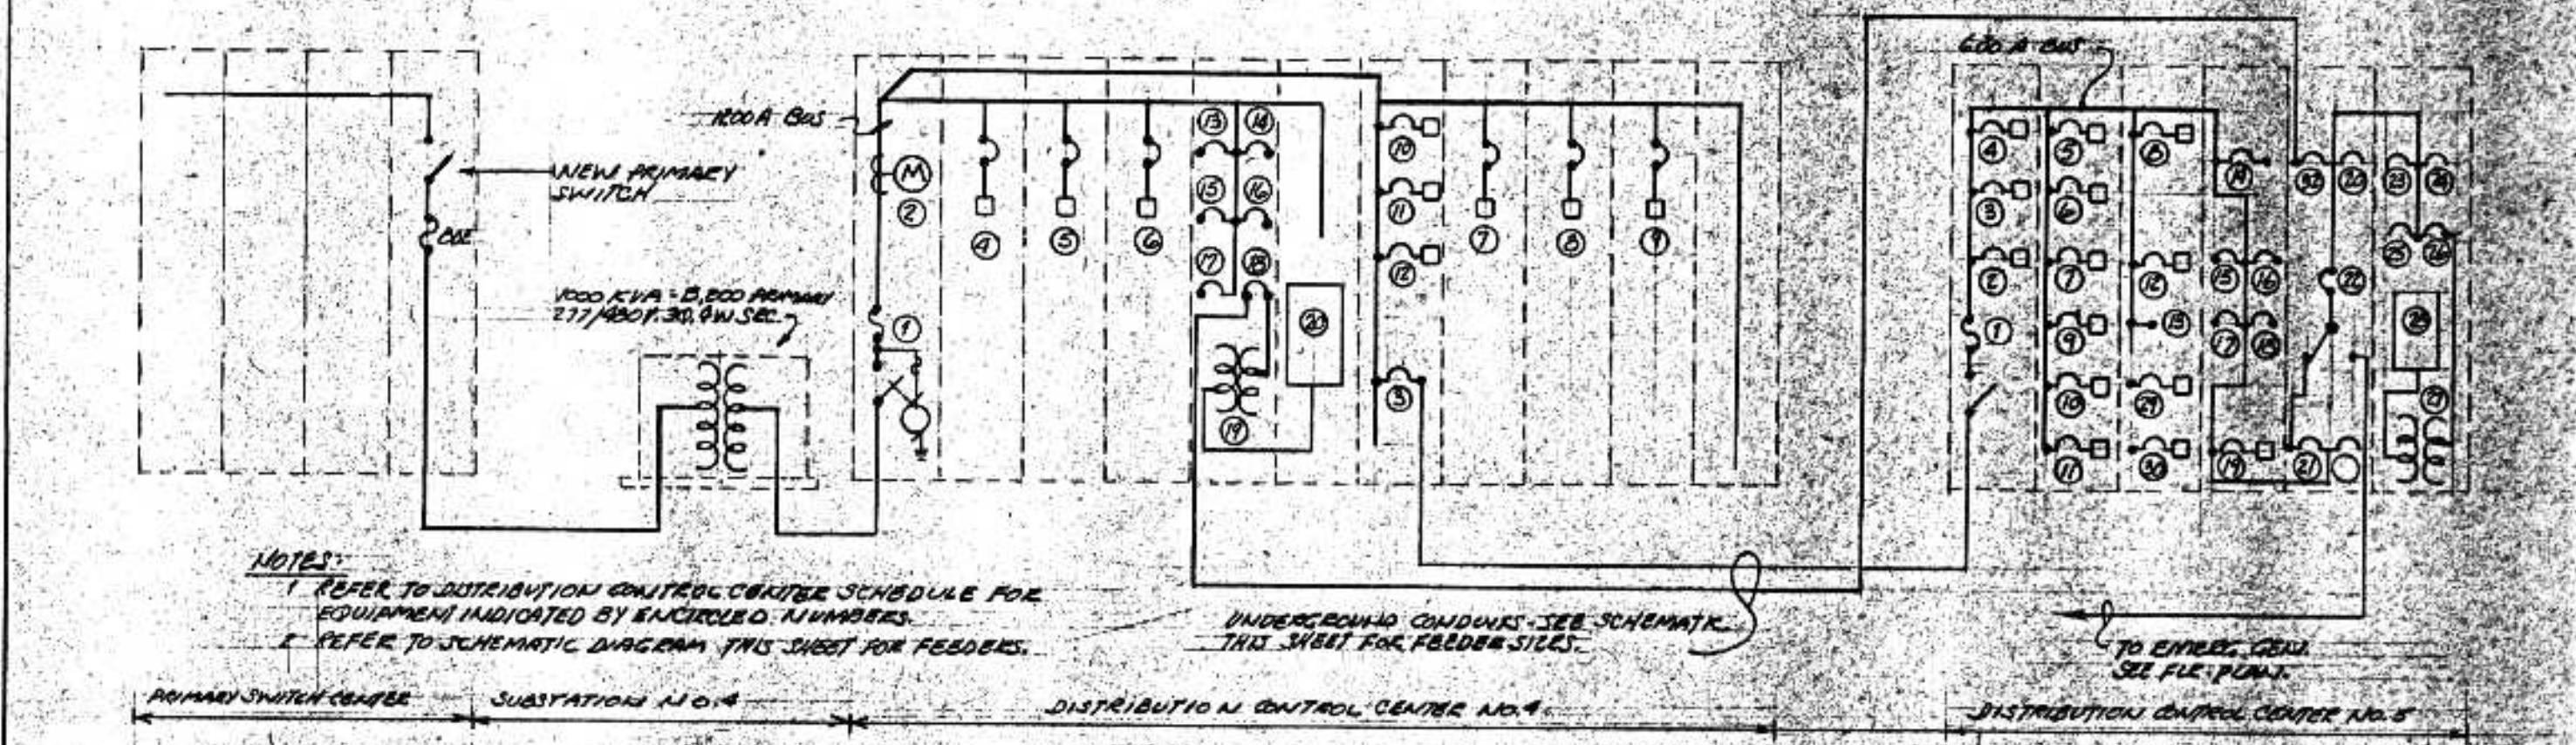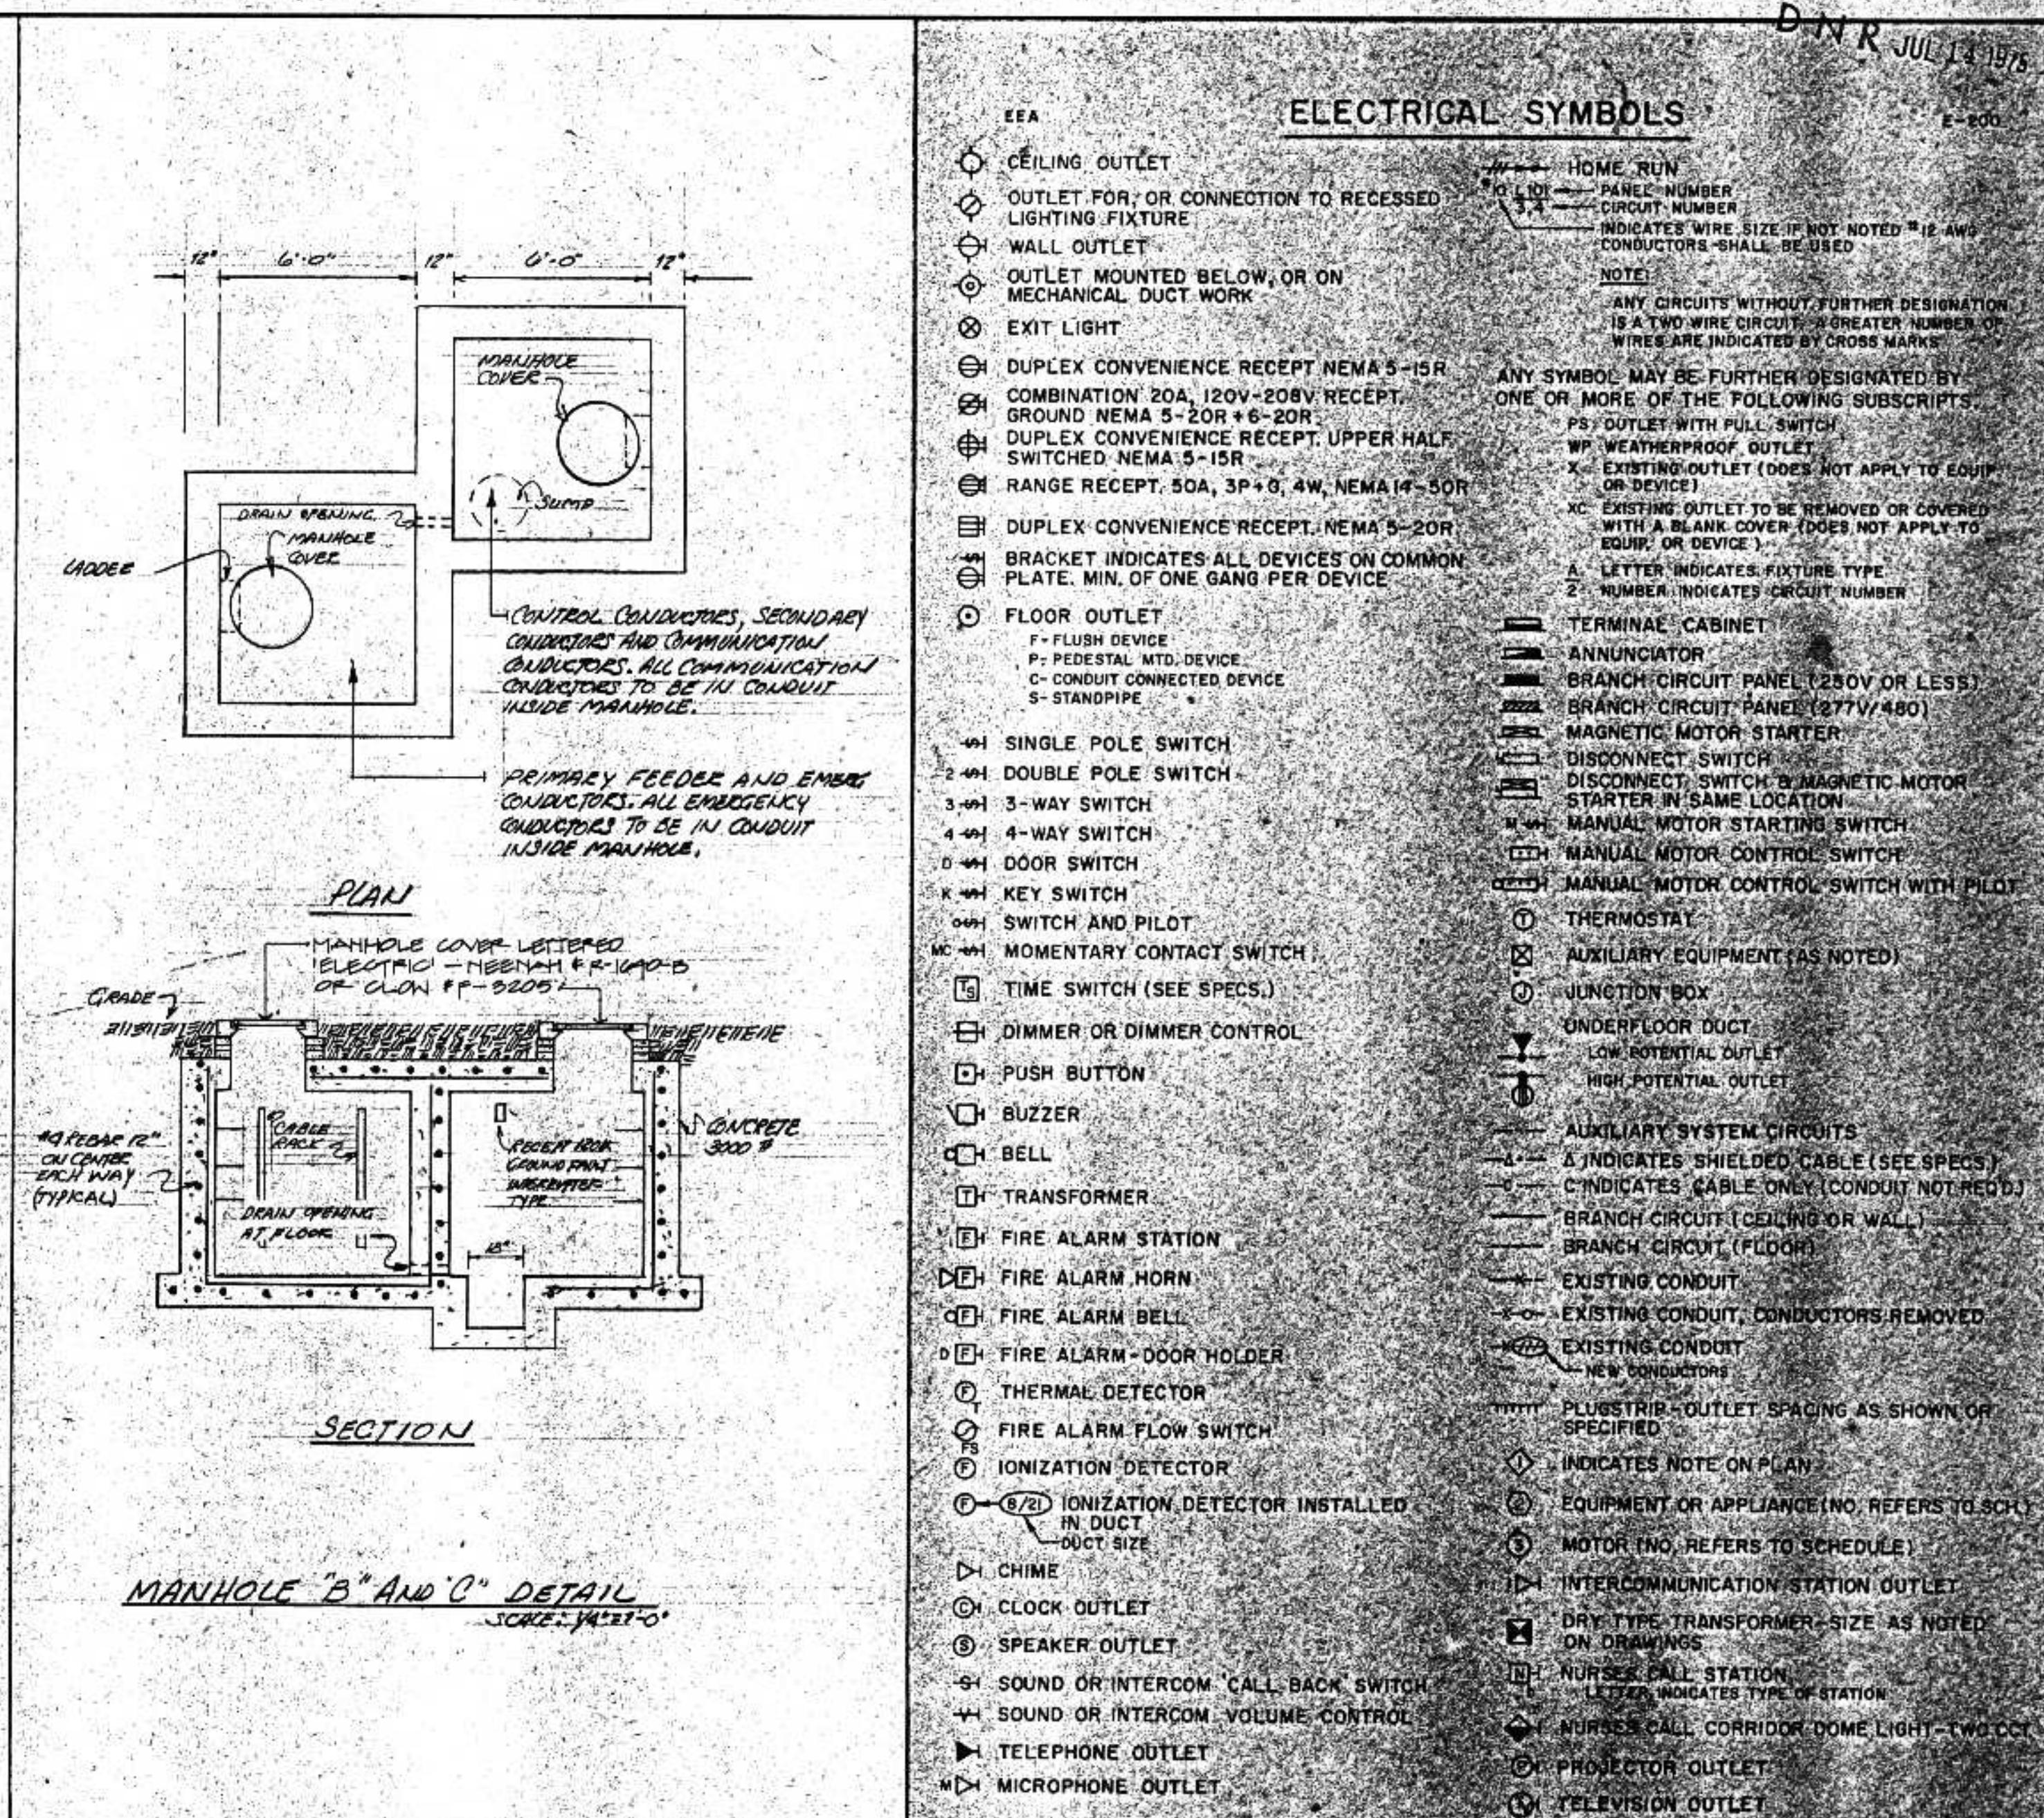

ONE LINE DIAGRAM OF THE POWER DISTRIBUTION SYSTEM

NPS

BONESTROO, ROSENE, ANDERLIK & ASSOC., INC.
ST. PAUL, MINNESOTA

SUPERIOR, WISCONSIN
DATE: JUNE 14, 1975 COMM 68881

ELECTRICAL
UNDERGROUND SCHEMATIC
50%

CITY OF SUPERIOR, WISCONSIN DEPARTMENT OF PUBLIC WORKS

PLANS FOR THE CONSTRUCTION OF CONTRACT 2

PRELIMINARY TREATMENT IMPROVEMENTS AT THE MAIN WASTEWATER TREATMENT PLANT

CITY OF SUPERIOR

HERBERT W. BERGSON
MAYOR

CONSOER TOWNSEND & ASSOCIATES


THOMAS L. NOERENBERG, P.E.
NO. E-23049

DEPT. OF PUBLIC WORKS

JEFF VITO
DIRECTOR


MARK DRAKE
SUPERINTENDENT

PRELIMINARY
JUN 17 1994

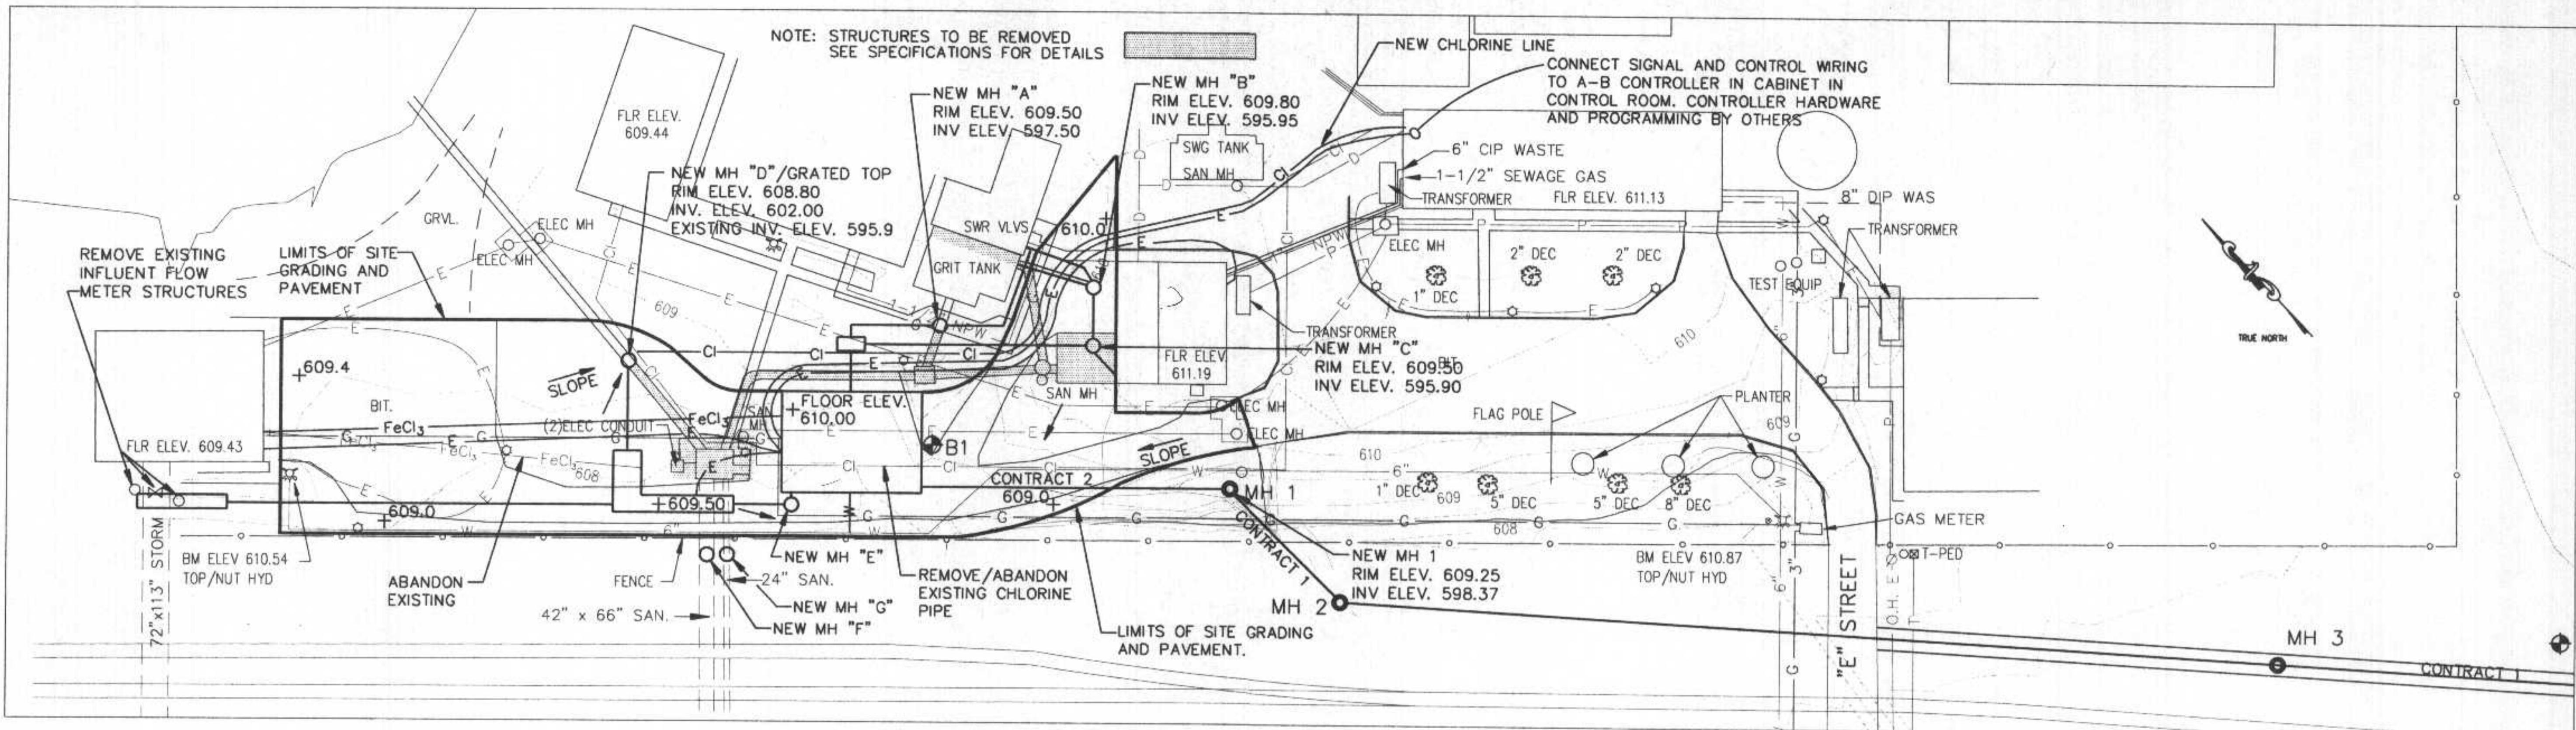

NOTE:
CONSTRUCTION OF CONTRACT NO. 1 INCLUDES ALL
PIPING AND STRUCTURES BETWEEN MANHOLE 1 AND
DIVERSION STRUCTURE IN EAST 2ND STREET.
CONTRACT NO. 2 WILL INCLUDE THE PIPING BETWEEN
THE NEW SCREEN BUILDING AND MANHOLE 1 ON
THE PLANT SITE.


PROPOSED SITE PLAN

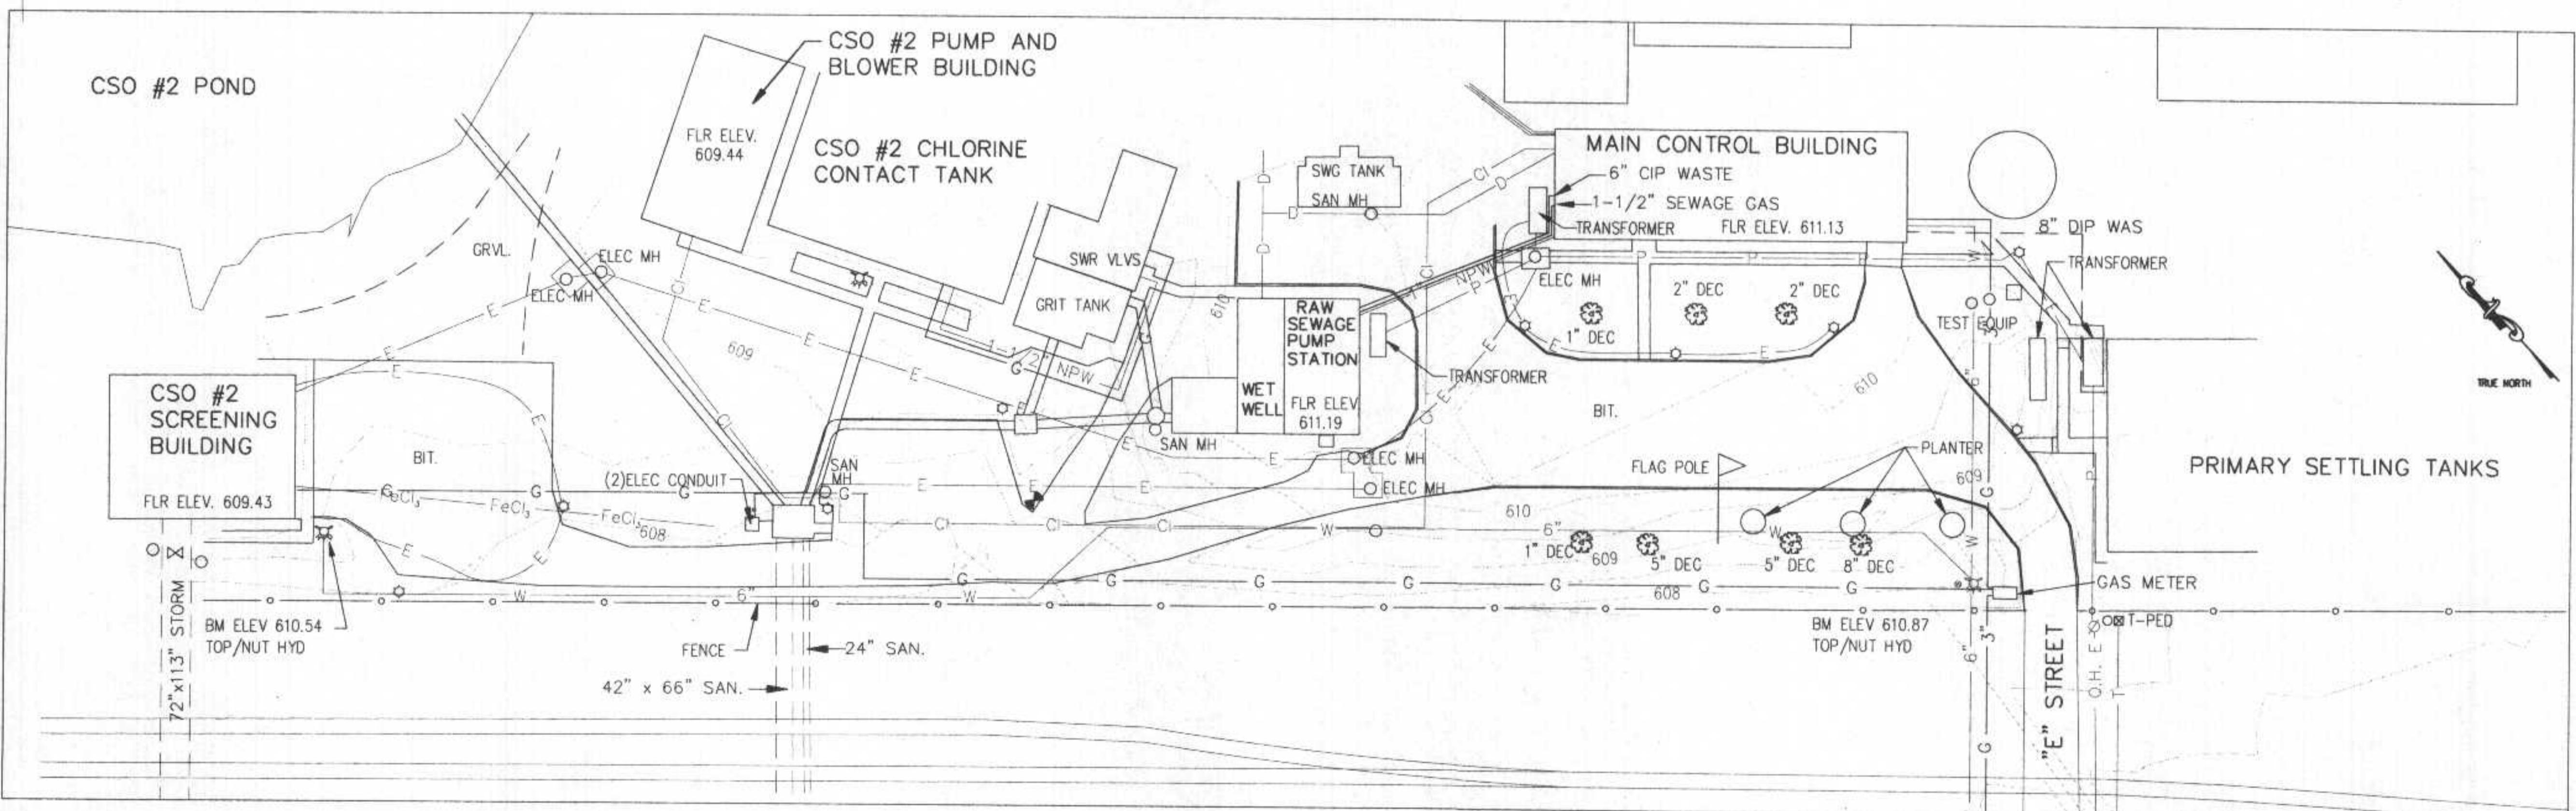

EXISTING SITE PLAN

NO.	DATE	DESCRIPTION	APPROVED
		REVISIONS	

DESIGNED	TN
DRAWN	LED
CHECKED	
DATE	APRIL, 1994

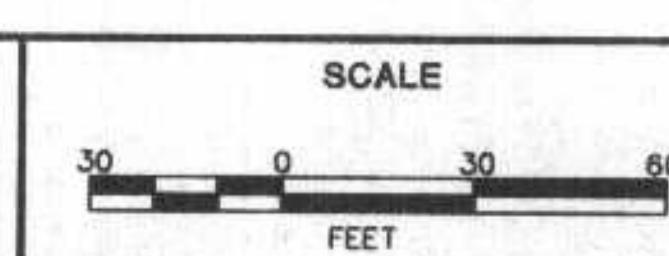

DEPARTMENT OF PUBLIC WORKS
CITY OF SUPERIOR, WISCONSIN



SUPERIOR WASTEWATER TREATMENT PLANT
UNDERGROUND UTILITY SITE MAP

SHEET
OF
RECORD MAP NO.
CT&A PROJECT NO.
3899-00

CITY OF SUPERIOR, WISCONSIN DEPARTMENT OF PUBLIC WORKS

PLANS FOR THE CONSTRUCTION OF CONTRACT 5

OPERATIONS BUILDING MODIFICATION AND ADDITION

CITY OF SUPERIOR

MARGARET CICCONE
MAYOR

CONSOER TOWNSEND ENVIRODYNE ENGINEERS


Jeff C. Cook
JEFF C. COOK, P.E.
NO. E-26997



DEPT. OF PUBLIC WORKS

JEFF VITO
DIRECTOR



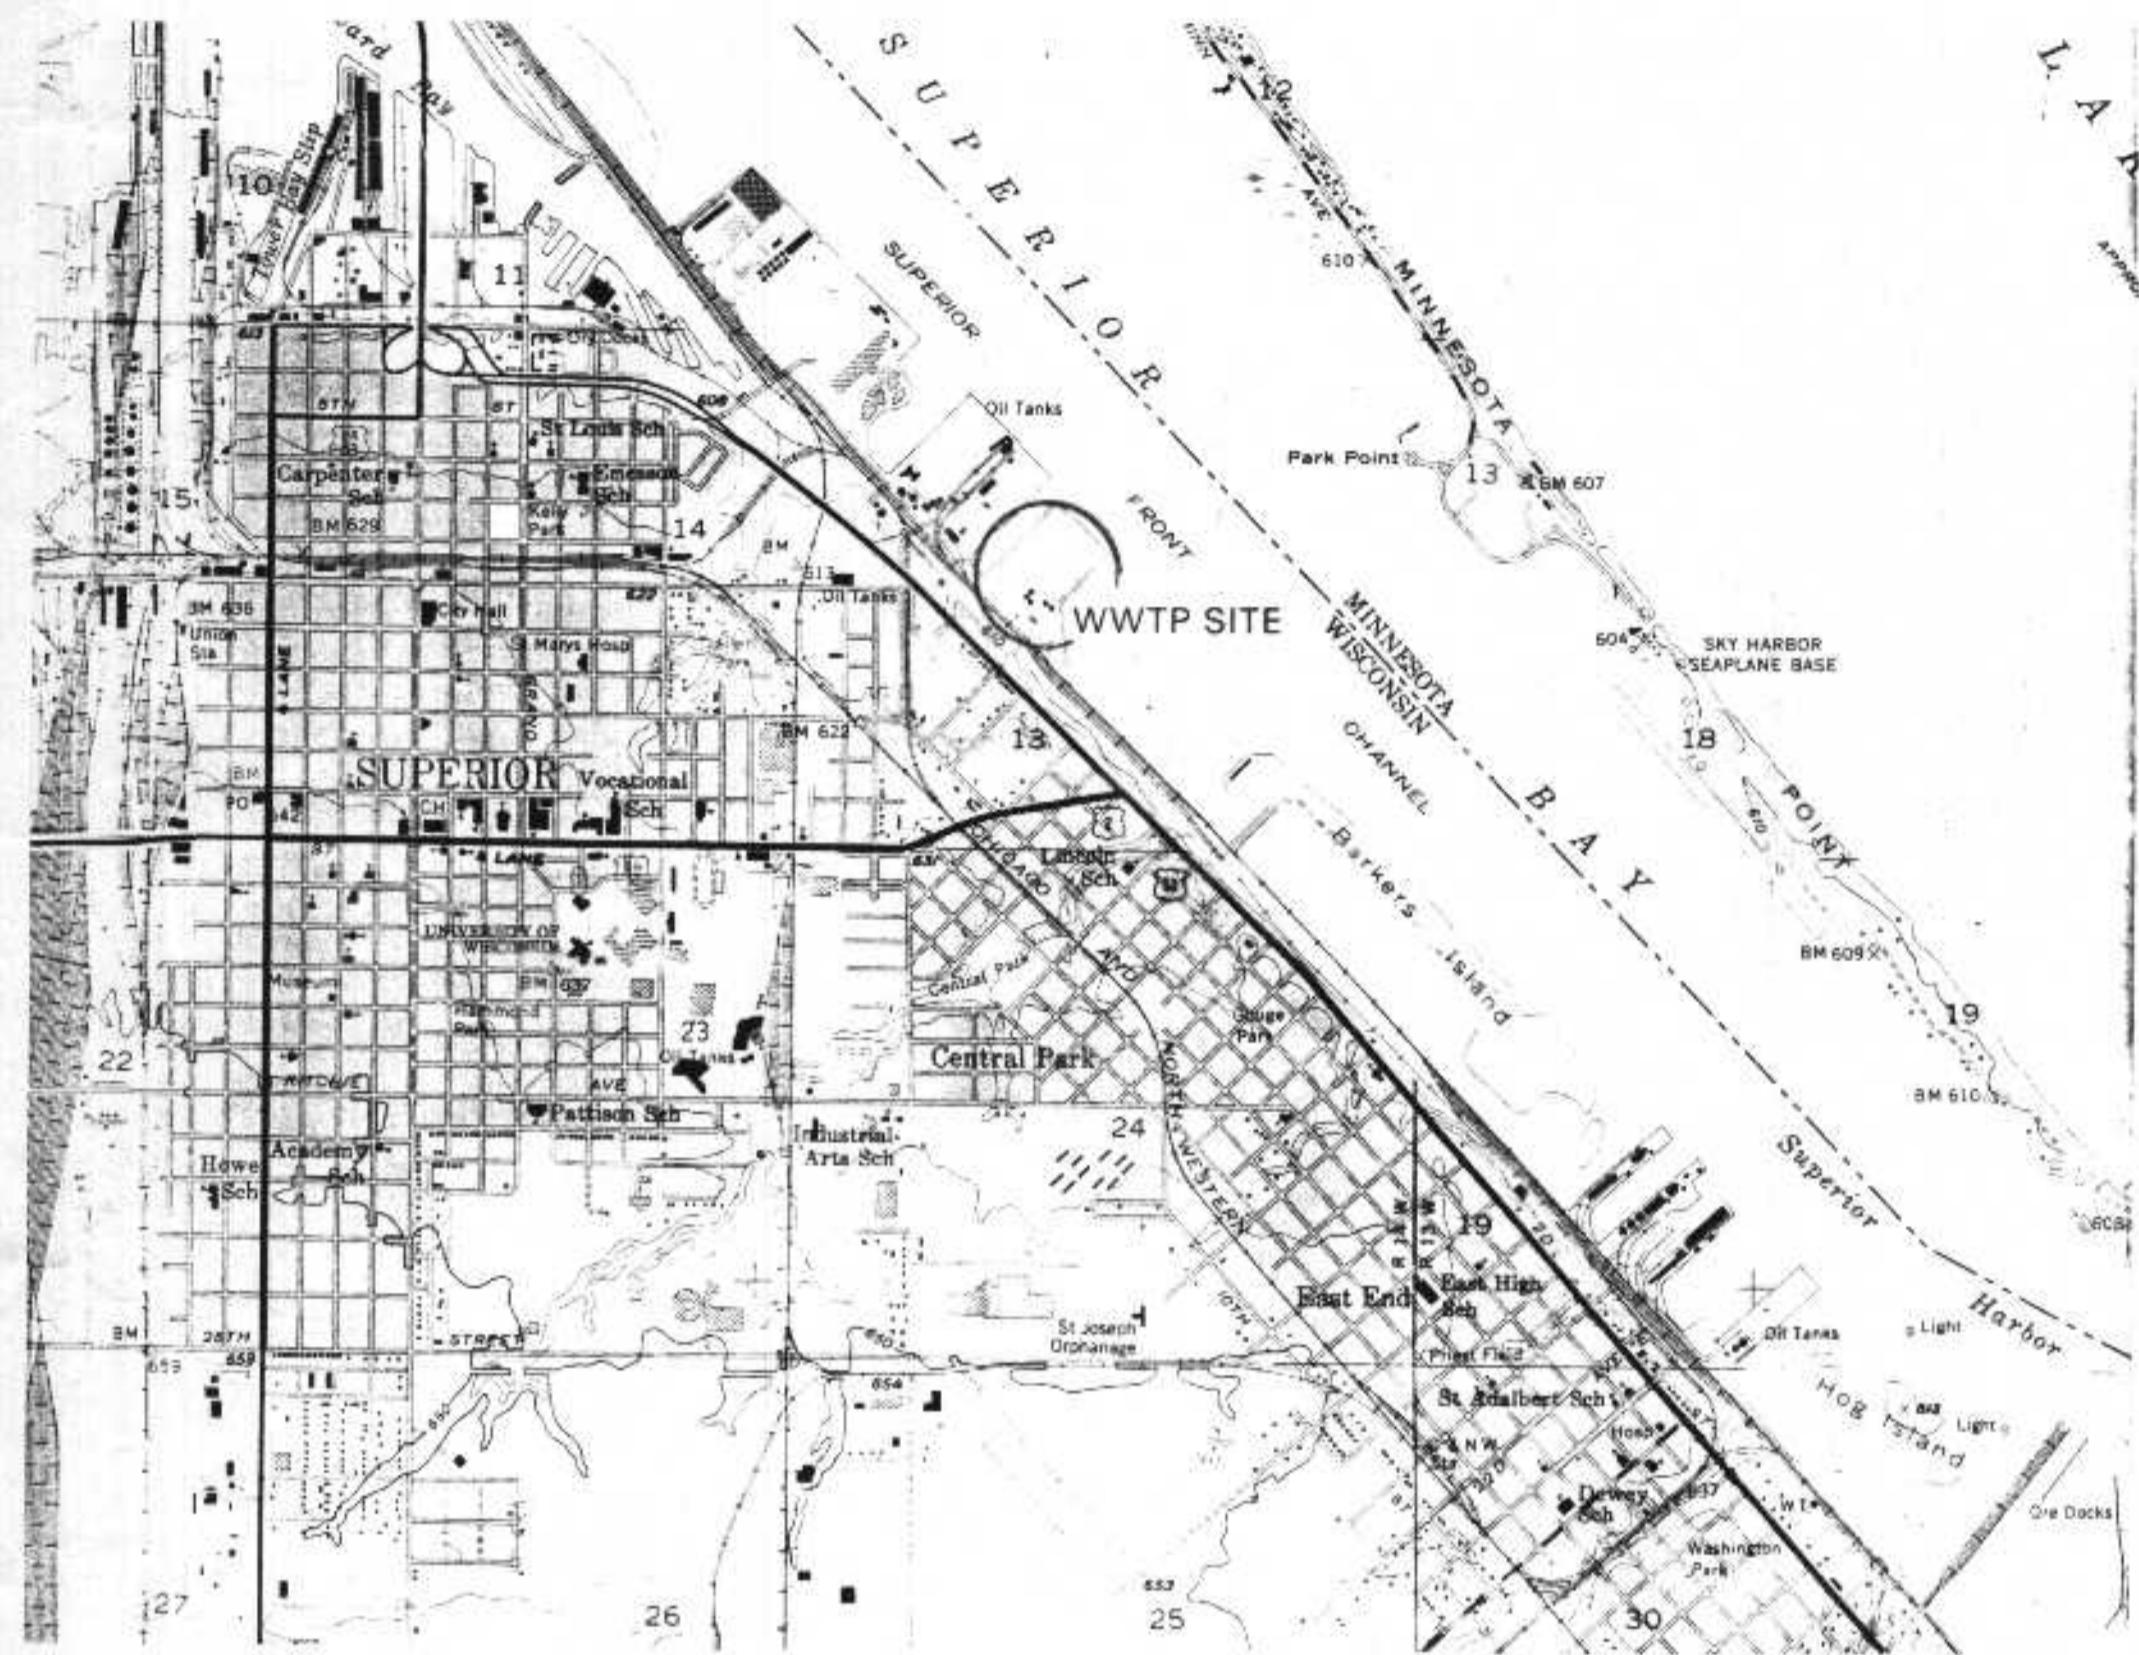

LIST OF CONTRACT DRAWINGS

Sheet No. Title

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A-3	PLAN - SECOND FLOOR
A-4	EXTERIOR ELEVATIONS
A-5	EXTERIOR ELEVATIONS
A-6	BUILDING AND STAIR SECTIONS
A-7	WALL SECTIONS
A-8	DETAIL SHEET
A-9	INTERIOR ELEVATIONS
A-10	ROOF PLAN & DETAILS
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S-3	STRUCTURAL ROOF FRAMING PLAN
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S-6	STRUCTURAL SECTION AND DETAILS - SHEET 2
S-7	STRUCTURAL TYPICAL FOUNDATION DETAILS - SHEET 1
S-8	STRUCTURAL TYPICAL FOUNDATION DETAILS - SHEET 2
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PL-1	FIRST FLOOR PLAN PLUMBING
PL-2	SECOND FLOOR PLAN PLUMBING
PL-3	PLUMBING PIPE SPACE PLAN & WATER DISTRIBUTION DIAGRAM
PL-4	PLUMBING DIAGRAMS
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M-1	FIRST FLOOR PLAN HVAC
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M-3	MECHANICAL SCHEDULES
E-1	ELECTRICAL FIRST FLOOR PLAN LIGHTING
E-2	ELECTRICAL FIRST FLOOR PLAN POWER
E-3	ELECTRICAL SECOND FLOOR PLAN LIGHTING
E-4	ELECTRICAL SECOND FLOOR PLAN POWER
E-5	ELECTRICAL SCHEDULES
E-6	ELECTRICAL SCHEDULES
E-7	ELECTRICAL RISER DIAGRAM
E-8	ELECTRICAL ABBREVIATIONS AND SYMBOLS

ADDITION AND ALTERATION
 HEATING AND VENTILATING
 BUILDING PLANS
 Conditionally
APPROVED
 DEPARTMENT OF INDUSTRY, LABOR AND HUMAN RELATIONS
 See Correspondence
 95-10-0836-B
 11-15-95



DESIGNED _____	SCALE _____
DRAWN _____	
CHECKED _____	
DATE _____	
NO. _____ DATE _____	DESCRIPTION _____ APPROVED _____
REVISIONS	



LHB ENGINEERS & ARCHITECTS
DULUTH • MINNEAPOLIS



BETA ENGINEERING, INC.
Engineers/Planners
1420 PROVIDENCE HIGHWAY, NORWOOD, MA
6 BLACKSTONE VALLEY PLACE, LINCOLN, RI
TEL 218/721-8446 o FAX 218/721-8456

DEPARTMENT OF PUBLIC WORKS
CITY OF SUPERIOR, WISCONSIN



OPERATIONS BUILDING MODIFICATION AND ADDITION
LOCATION MAP AND INDEX OF DRAWINGS

sheet G-1

of 2

sheets

PROJECT NO. 3899-05

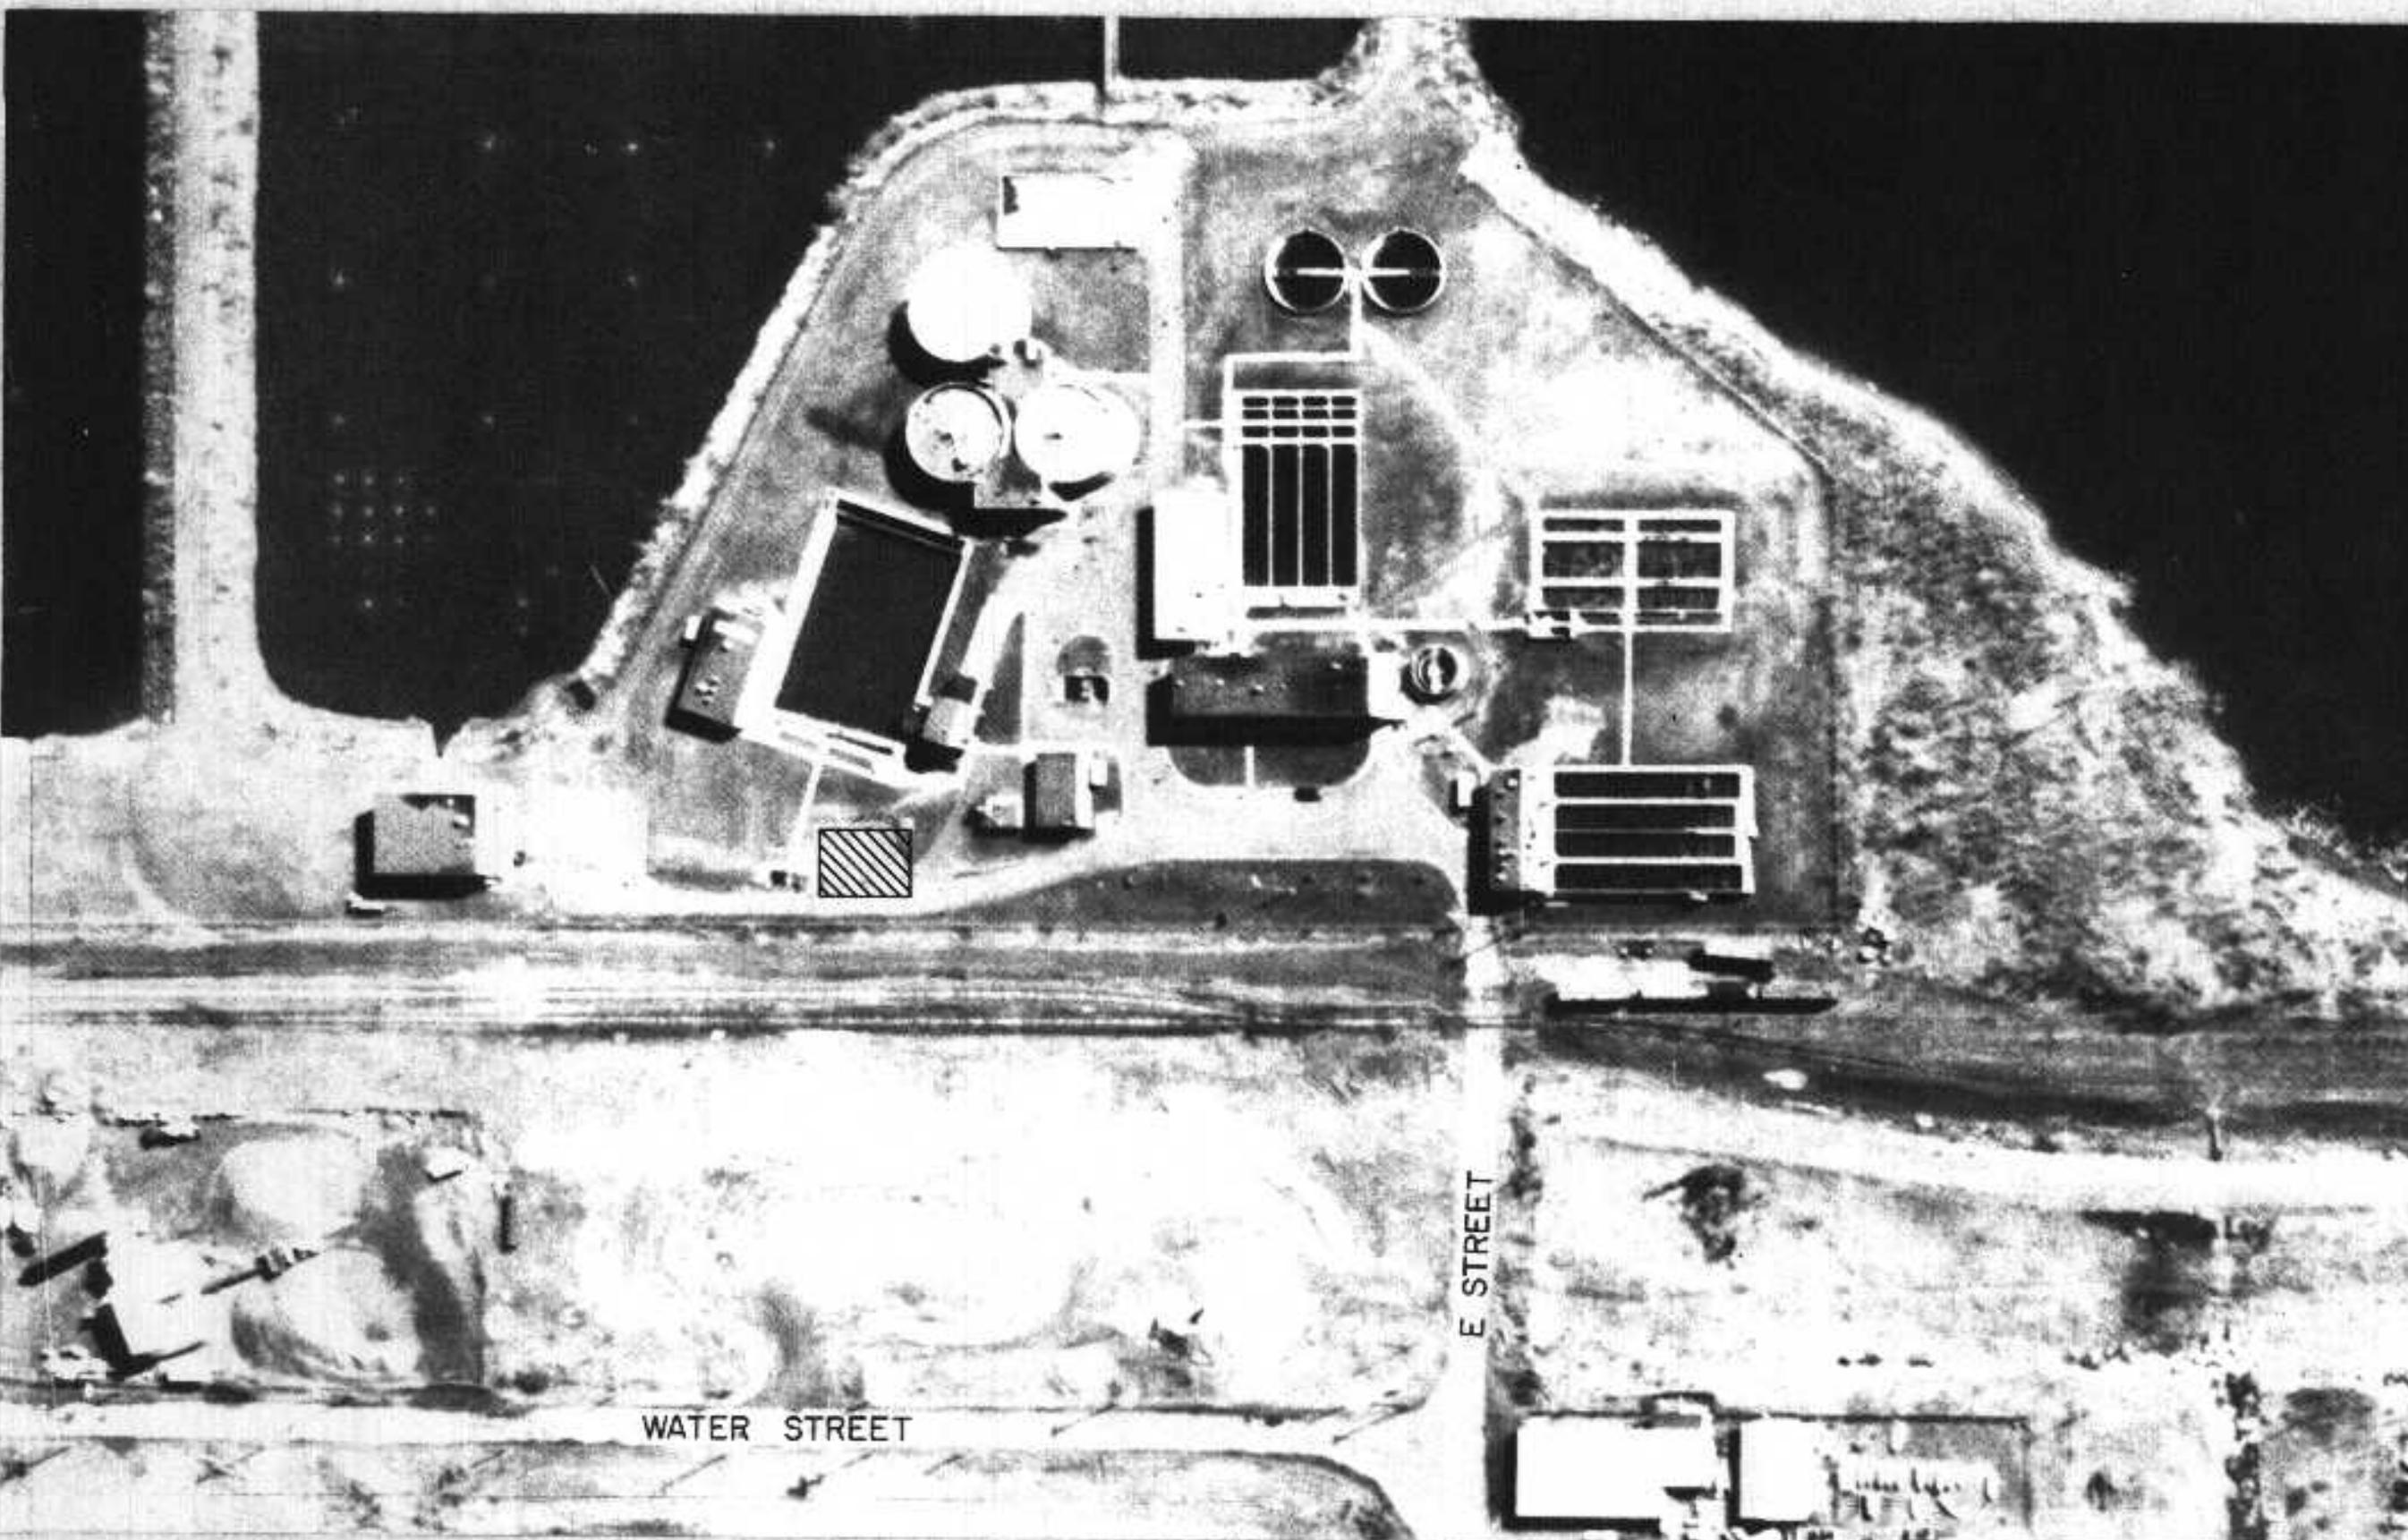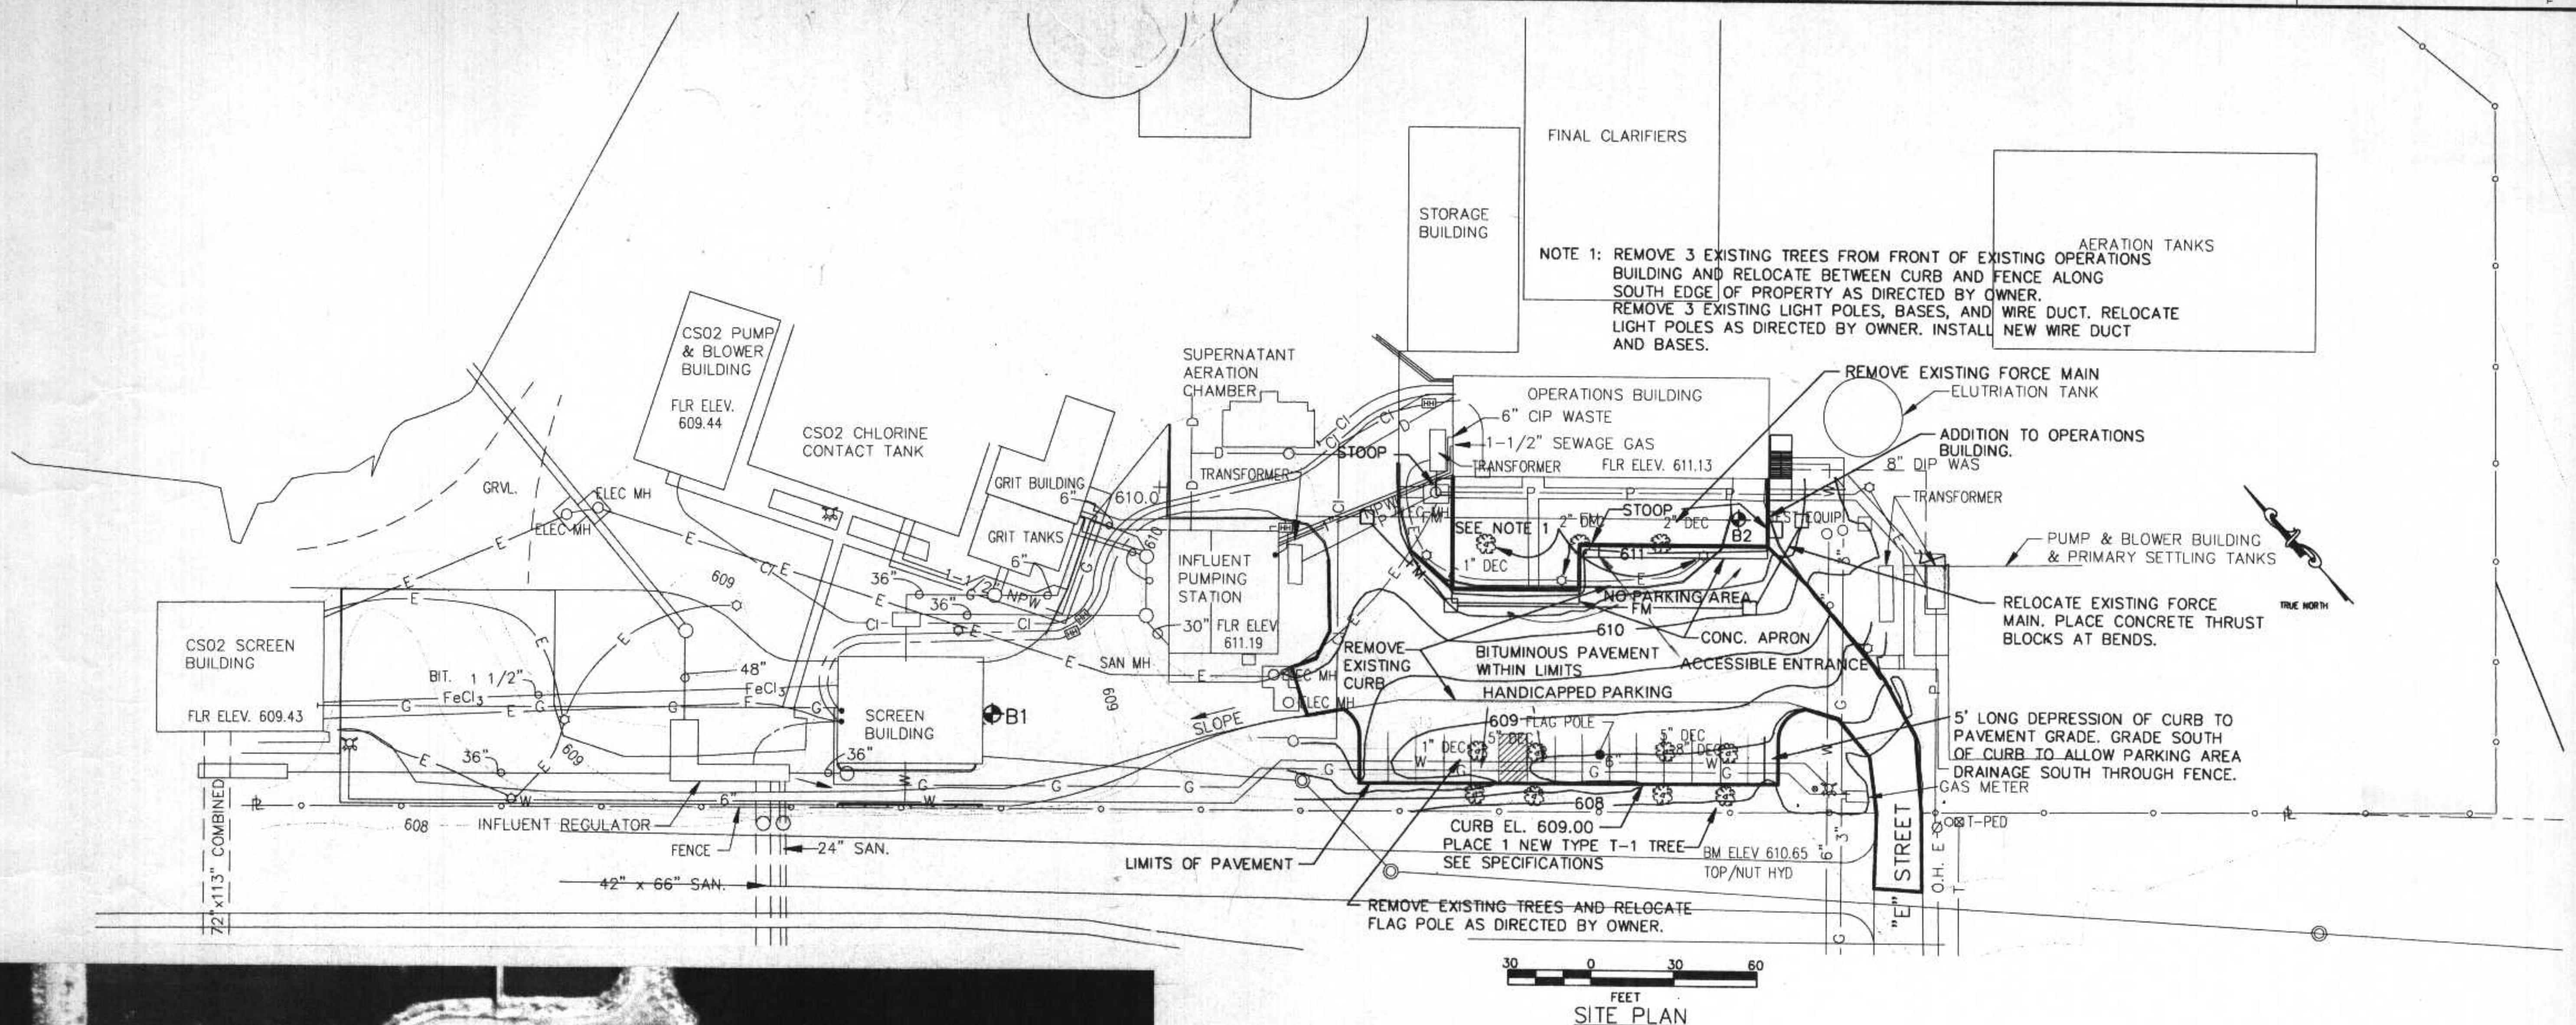

FEET

SITE AERIAL PHOTO (1991)

SITE AERIAL PHOTO (1991)

M:\PROJECTS\388905\MOO\S-PLTS\DWG Plotted on 10/25/1995 @ 10:42 AM by INQUIRER

NO.	DATE	DESCRIPTION	APPROVED
REVISIONS			

SCA



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BETA ENGINEERING, INC.
Engineers/Planners
1420 PROVIDENCE HIGHWAY, NORWOOD, MA
6 BLACKSTONE VALLEY PLACE, LINCOLN, RI

**DEPARTMENT OF PUBLIC WORKS
CITY OF SUPERIOR, WISCONSIN**

SHEET G-2

05

<u>LEGEND</u>	
NON-POTABLE PLANT WATER	NPW
CAST IRON PIPE	C.I.P.
DUCTILE IRON PIPE	D.I.P.
WASTE ACTIVATED SLUDGE	WAS
ROUGHED IRON PIPE	W.I.
PRIMARY SERVICE DUCT	—P—
ELECTRICAL	—E—
CHLORINE LINE	—CI—
WATER	—W—
GAS	—G—
RAIN	—D—
FORCEMAIN SEWER	—FM—
SANITARY SEWER	— — —
RELOCATED FORCE MAIN	—FM—
CONCRETE THRUST BLOCKS x 2' x 3'H	<input type="checkbox"/>
OIL BORING LOCATION	


CITY OF SUPERIOR
DEPARTMENT OF PUBLIC WORKS
WWTP STORAGE AND BUILDING IMPROVEMENTS


JUNE, 1998

BUILDING IMPROVEMENT SHEETS

<u>SHEET NO.</u>	<u>TITLE</u>
1	COVER SHEET
2	SITE PLAN
3	MASONRY RENOVATION - DIGESTERS AND DIGESTER BUILDINGS
4	MASONRY RENOVATION - CSO2 SCREEN AND PUMP BUILDINGS
5	ROOF REPLACEMENT PLAN - DIGESTER BUILDINGS
6	ROOF DRAINAGE PLAN - DIGESTER BUILDINGS
7	STORAGE BUILDING PLAN
8	STORAGE BUILDING FOUNDATION

PREPARED BY:
RMA ENGINEERING COMPANY
DULUTH, MN.

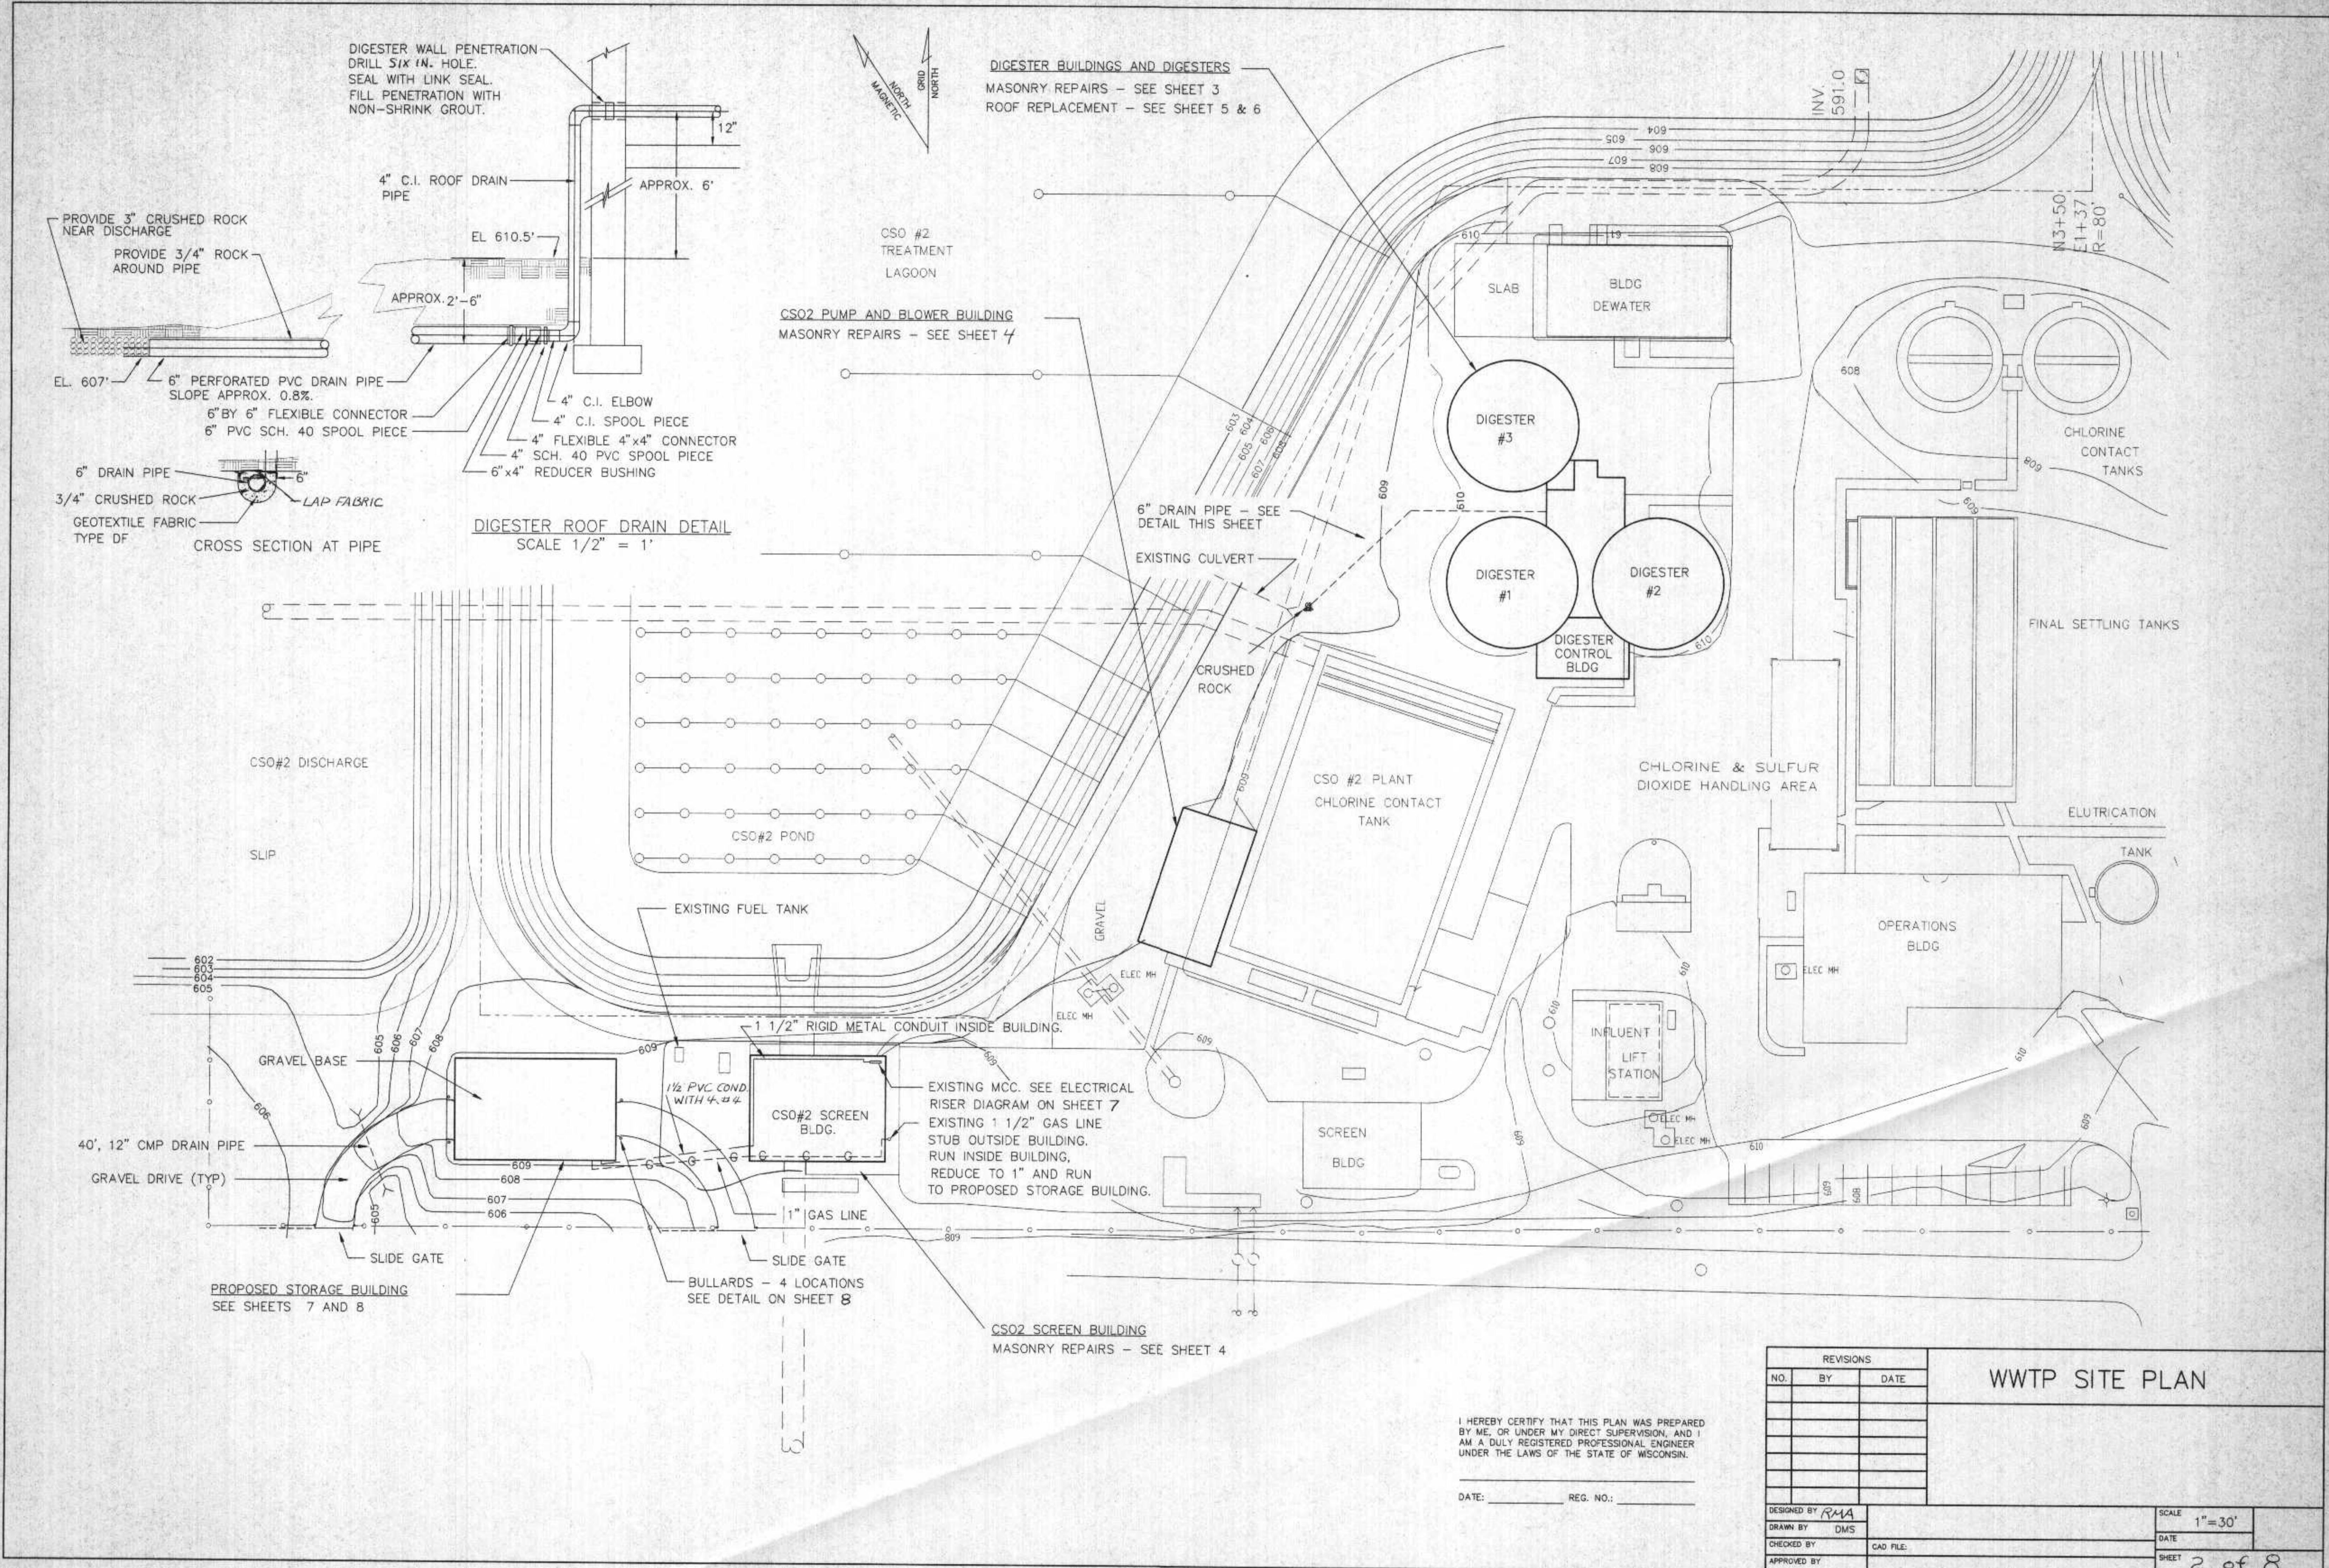

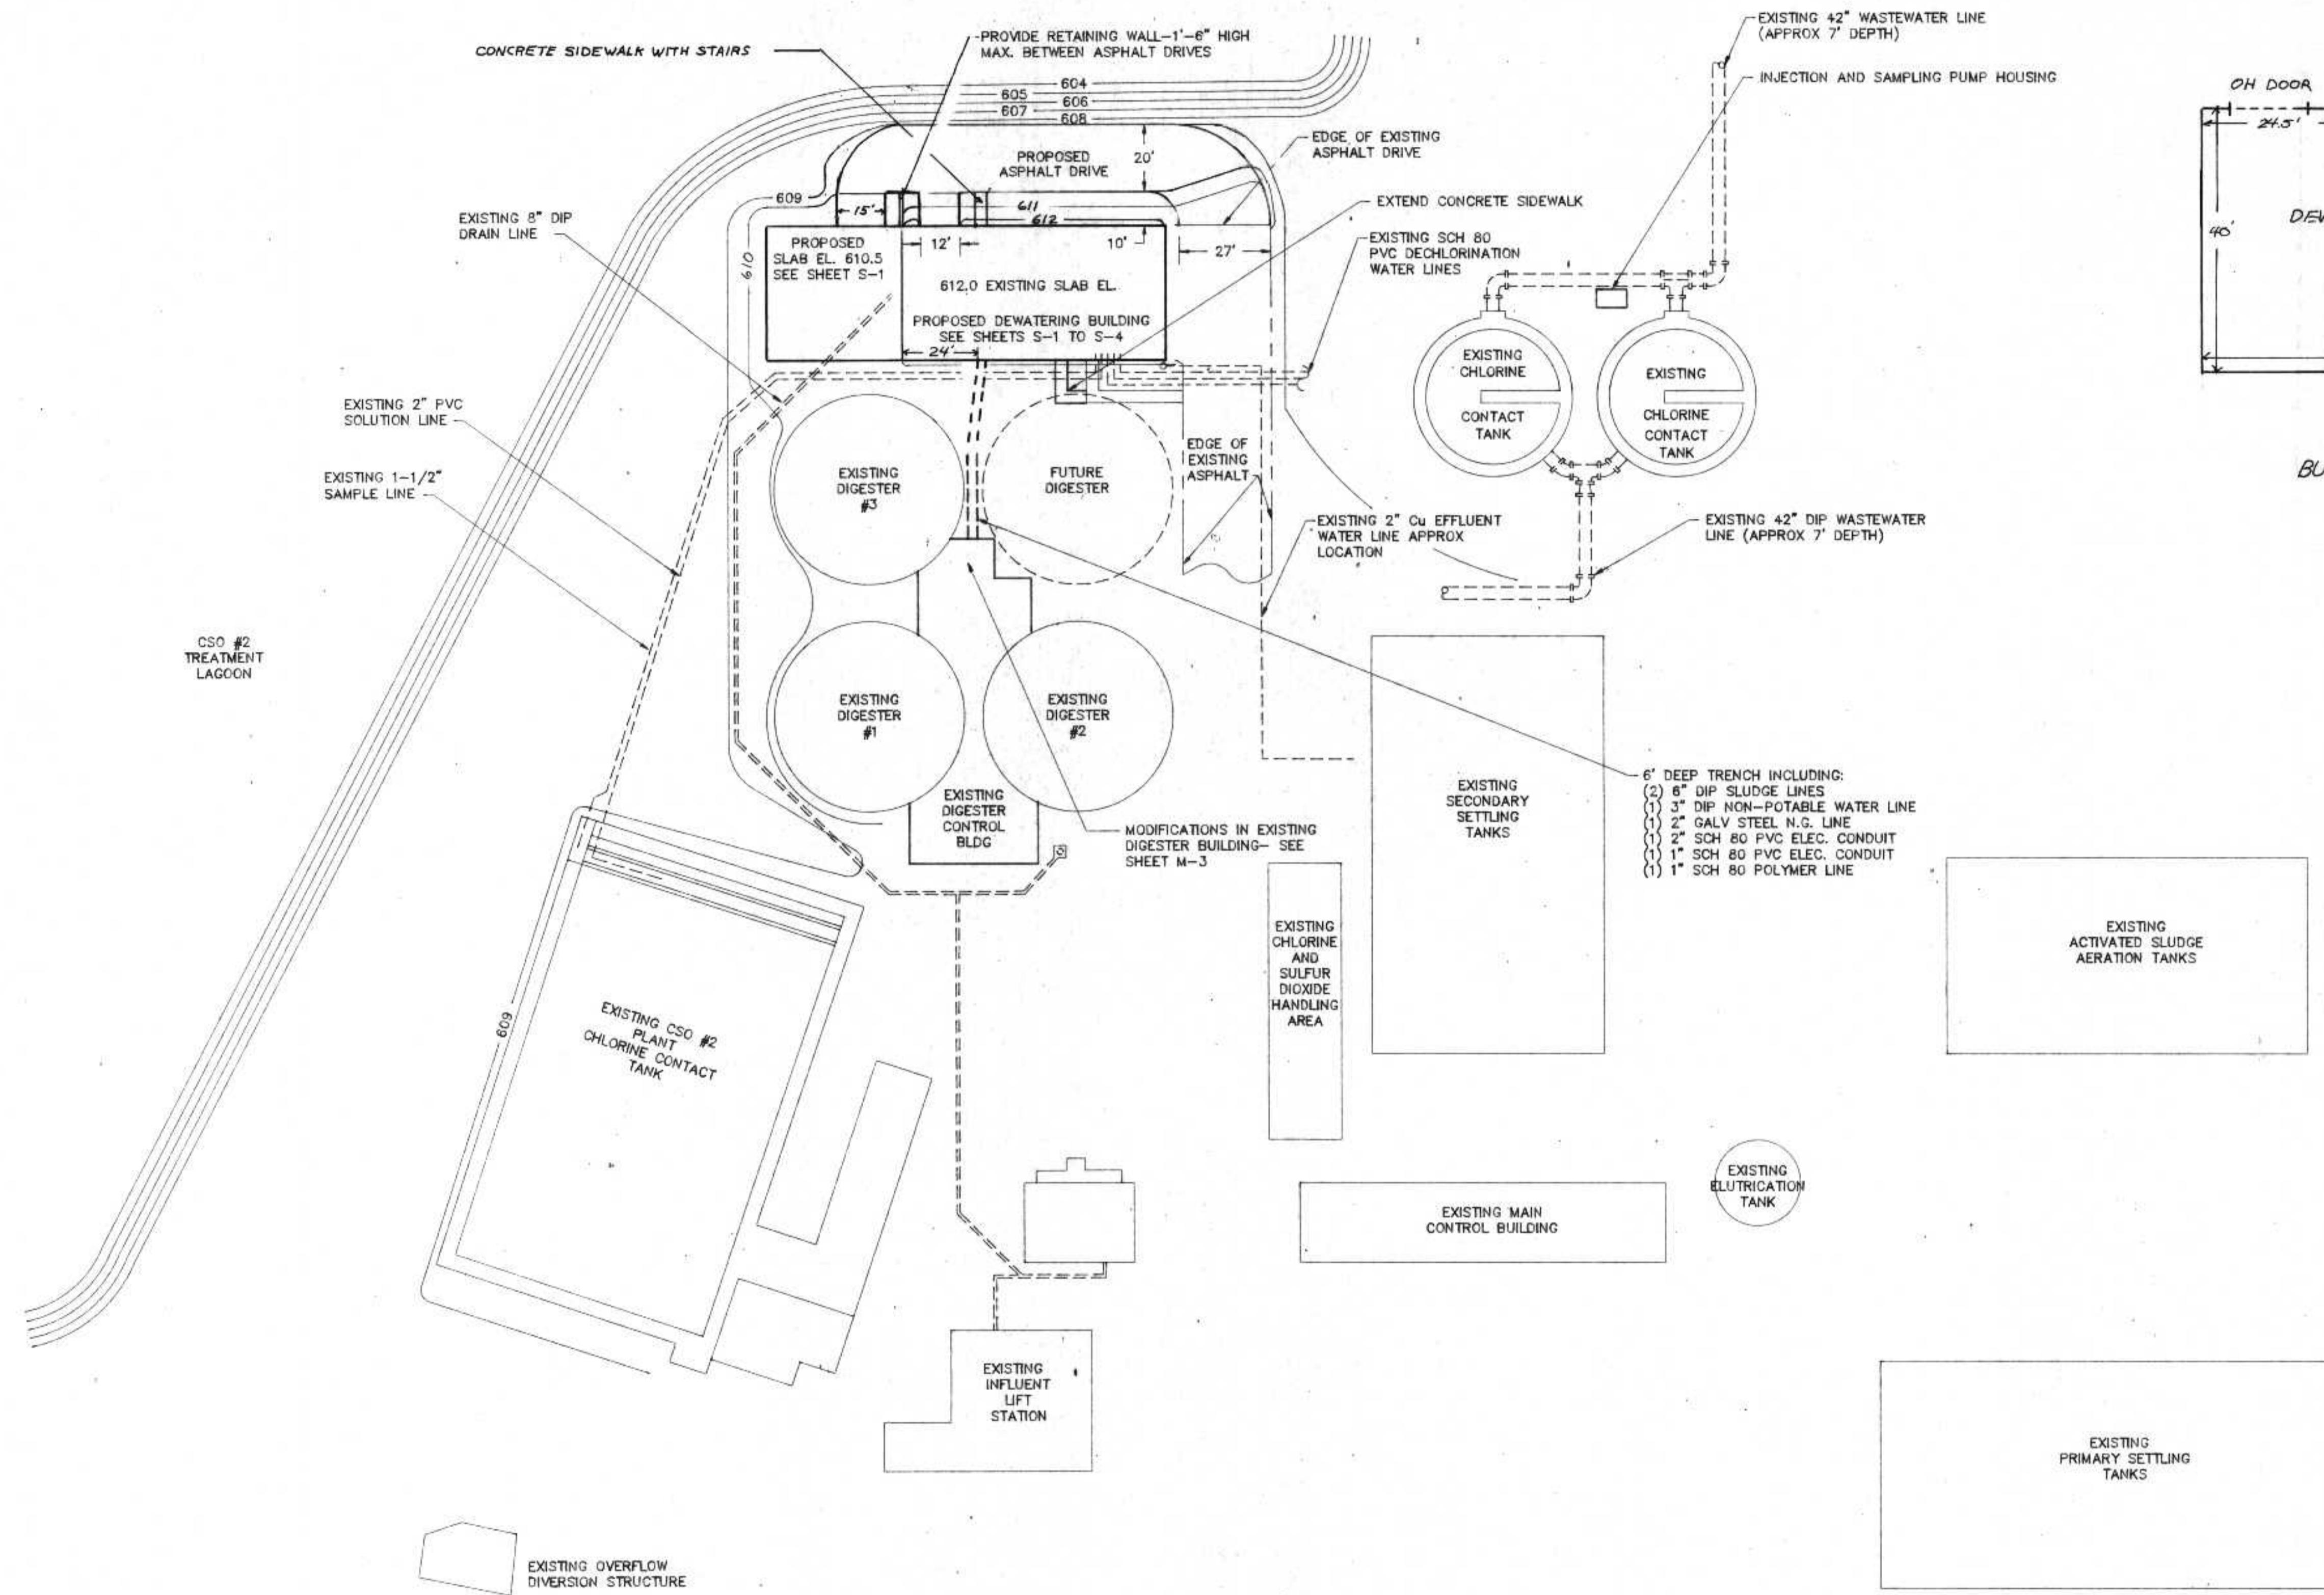

SITE PLAN NOTES

1. BUILDING CONTRACTOR RESPONSIBLE FOR CONCRETE WORK, DEWATERING BUILDING, ASPHALT DRIVE EXTENSION, SIDEWALK EXTENSION, NECESSARY RESEEDING AND ASPHALT PATCH AND NECESSARY GRADING WORK.
 2. MECHANICAL CONTRACTOR RESPONSIBLE FOR PIPE TRENCH AND YARD PIPING.
 3. ELECTRICAL SUB-CONTRACTOR (UNDER MECHANICAL) RESPONSIBLE FOR OUTSIDE ELECTRICAL DISTRIBUTION- SEE SHEET E-1.
 4. WORK UNDER THIS CONTRACT SHOWN IN DARK LINE
 5. ASPHALT DRIVE TO INCLUDE 6" GRAVEL SUBBASE (AS REQUIRED),
3" ASPHALT BASE COURSE, AND 1" ASPHALT SURFACE COURSE

I HEREBY CERTIFY THAT THIS PLAN WAS PREPARED BY ME, OR UNDER MY DIRECT SUPERVISION, AND I AM A DULY REGISTERED PROFESSIONAL ENGINEER UNDER THE LAWS OF THE STATE OF WISCONSIN.

Richard Anthony
DATE: 6/24/81 REG. NO. 25488

REVISIONS			SITE PLAN
NO.	BY	DATE	
1	Rma	3/22/91	

CITY OF SUPERIOR, WISCONSIN
WASTE WATER TREATMENT PLANT
SLUDGE DEWATERING/HANDLING
FACILITIES